3. THE PROJECT SITE (I.E. PORTION OF THE SITE SUBJECT OF THIS APPLICATION) IS

PHONE: (609) 624-1085


4. AREA OF THE SITE = 174.30 ACRES (LOTS 2, 3 & 4, BLOCK 235, LOTS 1 & 2, BLOCK 236 AND LOTS 38-43, 49 & 51, BLOCK 245).

OCEAN VIEW, NEW JERSEY 08230-0607


- 5. THE PROJECT SITE IS LOCATED WITHIN THE CAFRA BOUNDARY; HOWEVER THE PROPOSED DEVELOPMENT AT THIS LOCATION IS NOT A REGULATED ACTIVITY.
- 6. THERE ARE NO MAPPED FRESHWATER OR COASTAL WETLANDS ON OR WITHIN 150' OF
- 7. THE PROJECT SITE IS NOT LOCATED WITHIN THE PINELANDS PROTECTION AREA.
- 8. THE CONTRACTOR SHALL CHECK AND VERIFY ALL DIMENSIONS AND CONDITIONS AT THE SITE PRIOR TO COMMENCEMENT OF ANY WORK, AND SHALL ALSO VERIFY ALL DIMENSIONS WITH THE ARCHITECTURAL PLANS AND OTHER RELATED PLANS. ANY DISCREPANCIES SHALL BE REPORTED TO THE ENGINEER AND RESOLVED BEFORE PROCEEDING WITH THE WORK IN
- 9. DO NOT SCALE DRAWINGS; FIGURED DIMENSIONS GOVERN.
- 10. NO ADDITIONAL SANITARY SEWAGE FACILITIES ARE PROPOSED.
- 11. NO ADDITIONAL DOMESTIC WATER SUPPLY OR SITE WELL ARE PROPOSED.
- 12. 6 ADDITIONAL PARKING SPACES ARE PROVIDED.
- 13. (1) ONE AREA LIGHT AT THE ENTRANCE TO THE PROPOSED DRIVEWAY IS PROPOSED.
- 14. (1) ONE 4'x6' SITE SIGN AT DRIVEWAY ENTRANCE IS PROPOSED.
- 15. BUILDING OPERATIONS PLAN:
- THE PROJECT IS PROPOSED TO BE A SECONDARY ENTRANCE FOR THE CAMPGROUND.
- A. THERE ARE NO NEW EMPLOYEES PROPOSED FOR THIS PROJECT. B. THERE WILL BE NO PROPOSED SHIFTS TO BE WORKED, THE PROPOSED BUILDING IS
- C. ANY TRUCK AND TRACTOR TRAILER TRAFFIC WILL BE ARRIVING THRU THE MAIN
- D. THE PROJECT SHOULD NOT CAUSE ANY ADVERSE NOISE, GLARE, AIR, OR WATER
- E. THE PROPOSED FACILITY SHOULD POSE NO SAFETY HAZARD TO THE EMPLOYEES.
- F. AT THE PRESENT TIME THERE ARE NO IMMEDIATE PLANS TO EXPAND THE PROPOSED FACILITY.
- 16. PROPOSED ELECTRIC SERVICE TO BE LOCATED UNDERGROUND FROM EXISTING ON SITE
- 17. LIST OF REGULATORY APPROVALS AND/OR PERMITS FOR THIS PROJECT: A. SITE PLAN APPROVAL FROM THE DENNIS TOWNSHIP CONSOLIDATED LAND USE
- B. SITE PLAN APPROVAL OR WAIVER FROM THE CAPE MAY COUNTY PLANNING BOARD.
- C. MUNICIPAL BUILDING CONSTRUCTION PERMIT.
- D. ANY AND ALL ADDITIONAL APPROVALS AND/OR PERMITS THAT MAY BE DEEMED
- 18. LIST OF REQUESTED VARIANCES AND/OR DESIGN WAIVERS:
- A. WAIVER OF PROVIDING AN ENVIRONMENTAL IMPACT STUDY PER SECTIONS 165-54(B)2(i) AND 165-55(B)1 OF THE CODE OF DENNIS TOWNSHIP. SINCE THERE ARE NO MAPPED ENVIRONMENTALLY SENSITIVE AREAS (IE WETLANDS) ON OR IMMEDIATELY ADJACENT TO THE PROJECT SITE, IT IS UNLIKELY THAT THIS PROJECT WOULD HAVE ANY SIGNIFICANT ADVERSE ENVIRONMENTAL IMPACT.
- B. WAIVER OF PROVIDING LOCATION OF LIGHTS, LIGHTING STANDARDS AND SIGNS WITHIN THE TRACT AND WITHIN ONE HUNDRED (100') FEET PER SECTION 165-54(B)2(b). THE LOCATION OF EXISTING LIGHTS AND SIGNS ON AND WITHIN 100' OF THE TRACT WILL HAVE NO ADVERSE IMPACT TO THIS PROJECT.
- C. WAIVER OF PROVIDING THE LOCATION OF ALL SEWERAGE AND WATER FACILITIES PER SECTION 165-54(B)2(d). THE PROPOSED GUARDHOUSE IS A NON-SEWAGE GENERATING OR WATER UTILIZING FACILITY, AND THE LOCATION OF EXISTING SEWERAGE AND WATER FACILITIES WILL HAVE NO ADVERSE IMPACT TO THIS PROJECT.
- D. ANY AND ALL ADDITIONAL VARIANCES AND/OR DESIGN WAIVERS THAT MAY BE DEEMED
- 19. PRIOR TO COMMENCEMENT OF ANY WORK, THE CONTRACTOR SHALL ARRANGE FOR A UTILITY MARK OUT AND OBTAIN VERIFICATION THAT THE PROPOSED WORK WILL NOT INTERFERE WITH OR DAMAGE ANY SUBSURFACE UTILITIES. CONTACT ONE CALL SYSTEM AT 1-800-272-1000 NO SOONER THAN (3) WORKING DAYS NOR GREATER THAN (10) WORKING DAYS BEFORE STARTING WORK.
- 20. ALL CONSTRUCTION SHALL BE IN ACCORDANCE WITH APPLICABLE CODES AND ORDINANCES, AND IN GOOD CONSTRUCTION PRACTICE.
- 21. CONTRACTOR IS ADVISED THAT IF THIS DOCUMENT DOES NOT CONTAIN A RAISED IMPRESSION SEAL OF THE PROFESSIONAL, IT IS NOT AN AUTHORIZED ORIGINAL DOCUMENT AND MAY HAVE BEEN ALTERED. THIS SITE PLAN IS NULL AND VOID UNLESS THE RAISED IMPRESSION SEAL OF THE SIGNING PROFESSIONAL ENGINEER IS AFFIXED HERETO.
- 22. THIS SITE PLAN AND ANY INFORMATION CONTAINED HEREIN, AS AN INSTRUMENT OF PROFESSIONAL SERVICE, IS THE PROPERTY OF GIBSON ASSOCIATES, P.A. AND IS NOT TO BE USED, IN WHOLE OR IN PART, FOR ANY OTHER PROJECT WITHOUT THE WRITTEN AUTHORIZATION OF GIBSON ASSOCIATES, P.A. GIBSON ASSOCIATES, P.A. SHALL RETAIN ALL COMMON LAW, STATUTORY LAW AND OTHER RESERVED RIGHTS, IN ADDITION TO THE
- 23. CONTRACTOR SHALL PAY PARTICULAR ATTENTION TO THE REVISIONS DATES LISTED IN THE REVISION SCHEDULE OF EACH DRAWING TO MAKE SURE THAT THE SET BEING WORKED FROM LISTS THE MOST RECENT AND/OR CURRENT REVISION DATE. DESIGN ENGINEER OR OWNER SHALL BE CONTACTED PRIOR TO STARTING WORK TO ENSURE CONTRACTOR IS WORKING FROM MOST RECENT SET OF PLANS. CONTRACTOR SHALL ALSO CHECK AND VERIFY ALL DIMENSIONS AND CONDITIONS AT THE SITE AND WITH THE ARCHITECTURAL PLANS OF THE PROJECT (PREPARED BY OTHERS). ANY DISCREPANCIES SHALL BE REPORTED TO THE DESIGN ENGINEER AND RESOLVED BEFORE PROCEEDING WITH WORK IN

SITE PLAN FOR TURNER PARTNERS, L.P.

PORTION OF LOT 3, BLOCK 235 **DENNIS TOWNSHIP** CAPE MAY COUNTY, NEW JERSEY

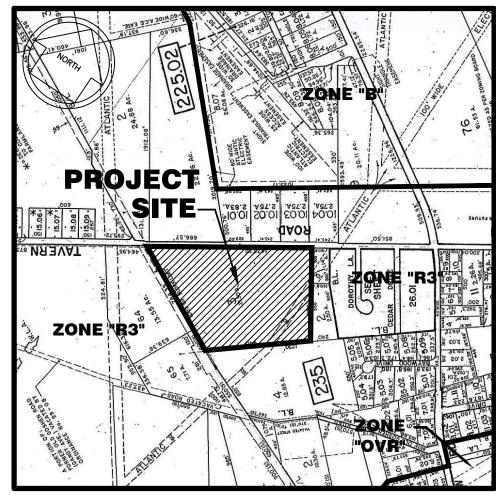


KEY & ZONING MAP

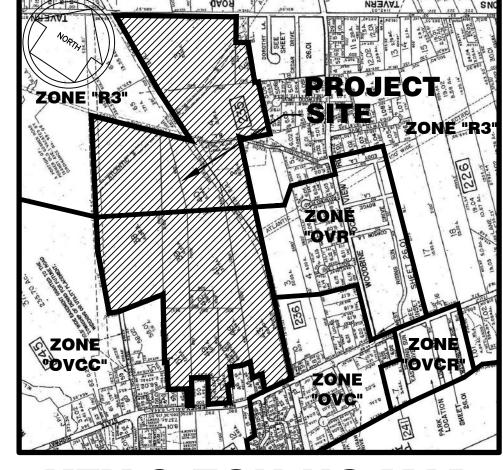


KEY & ZONING MAP




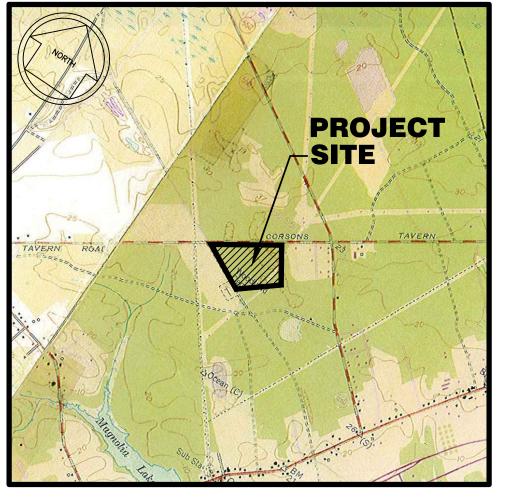

U.S.G.S. MAP WOODBINE AND SEA ISLE CITY QUADRANGLE SCALE: 1" = 2000'

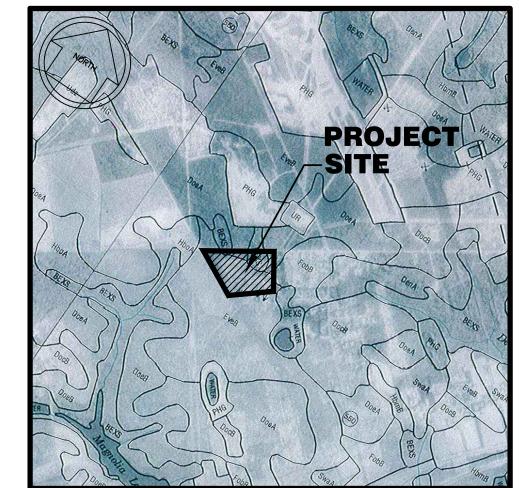

SOILS MAP SOILS MAP SHEET No. 6 & 7 SCALE: 1" = 2000'

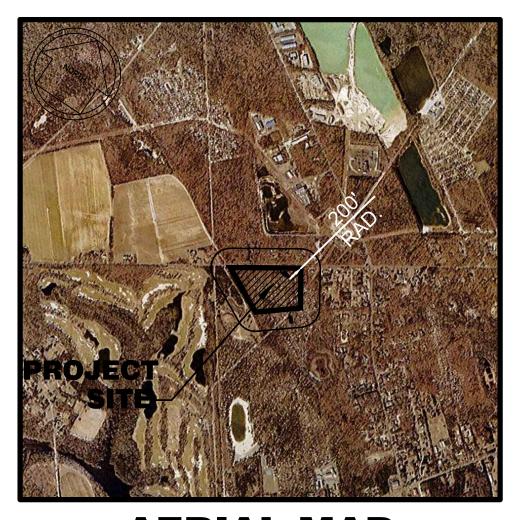

AERIAL MAP NO SCALE: LOCATION OF ADJACENT STRUCTURES WITHIN 200' OF THE PROJECT SITE

ZONING SCHEDULE: (ZONE "R-3" SINGLE FAMILY RESIDENTIAL)

DESCRIPTION	REQUIRED "R-3" ZONE	EXISTING	PROPOSED	VARIANCE
MINIMUM LOT AREA	3 ACRES	174.30± ACRES	174.30± ACRES	NO
MINIMUM LOT FRONTAGE	150'	702.80'	702.80'	NO
MINIMUM LOT WIDTH	150'	1115.98'	1115.98'	NO
MINIMUM LOT DEPTH	300'	4731'±	4731'±	NO
PRINCIPAL BUILDING				
MINIMUM FRONT YARD SETBACK	100'	167.8' *	132.6'**	NO
MINIMUM SIDE YARD SETBACK	35'	OVER 35'	OVER 35'	NO
MINIMUM REAR YARD SETBACK	100'	OVER 100'	OVER 100'	NO
MAXIMUM BUILDING COVERAGE	10%	UNDER 10%	UNDER 10%	NO
MAXIMUM IMPERVIOUS COVERAGE	15%	UNDER 15%	UNDER 15%	NO
MAXIMUM BUILDING HEIGHT	30'/2.5 STORIES	UNDER 30'/2.5 STORIES	UNDER 30'/2.5 STORIES	NO
ACCESSORY BUILDING				
MINIMUM SIDE YARD SETBACK	35'	N/A	N/A	NO
MINIMUM REAR YARD SETBACK	35'	N/A	N/A	NO
MAXIMUM BUILDING COVERAGE	2%	N/A	N/A	NO

^{*} FROM EXISTING GUARDHOUSE BUILDING ** FROM PROPOSED GUARDHOUSE BUILDING

TABLE OF CONTENTS

	3. 33.11.2 .11.3
SHEET	DESCRIPTION
1	COVER SHEET (GENERAL NOTES AND KEY MAPS)
2	PLAN OF SURVEY
3	SITE PLAN
4	DETAILS
5	200' LIST
6	SOIL EROSION & SEDIMENT CONTROL PLAN

APPROVALS:

APPROVED BY THE COUNTY PLANNING BOARD OF CAPE MAY COUNTY, NEW JERSEY.

VOID DATE DATE VOID DATE DATE APPROVED BY THE DENNIS TOWNSHIP CONSOLIDATED LAND USE BOARD, CAPE MAY COUNTY, NEW JERSEY.

VOID DATE DATE

CONSOLIDATED LAND USE BOARD ENGINEER

I HEREBY CERTIFY THAT I AM THE OWNER OF RECORD OF THE

SITE HEREIN DEPICTED, AND THAT I HAVE REVIEWED THIS PLAN


AND CONCUR WITH THIS SUBMISSION.


COVER SHEET

VOID DATE DATE

		PREPARED BY:			CONSULTIN 52:	ON ASSOCIAT IG ENGINEERS A 2 SEA ISLE BOL VIEW, NEW JER (609) 624–19	ND SURVEYO JLEVARD RSEY 08230	
		Louis a	Schart		PLAN FOR TUP TION OF LOT DENNIS T		·	
		LOUIS A. PROFESSIONA N.J.P.E. LICENS	L ENGINEER	CAPE	MAY COUN		JERSEY	
E	REVISIONS	DRAWN: RCO/JJS	CHECKED: WPF/WFS	DATE: 07-31-23	SCALE: AS SHOWN	SHEET 1 OF 6	DWG. No. 36	 338–2[

GIBSON ASSOCIATES, P.A. CONSULTING ENGINEERS AND SURVEYORS 522 SEA ISLE BOULEVARD

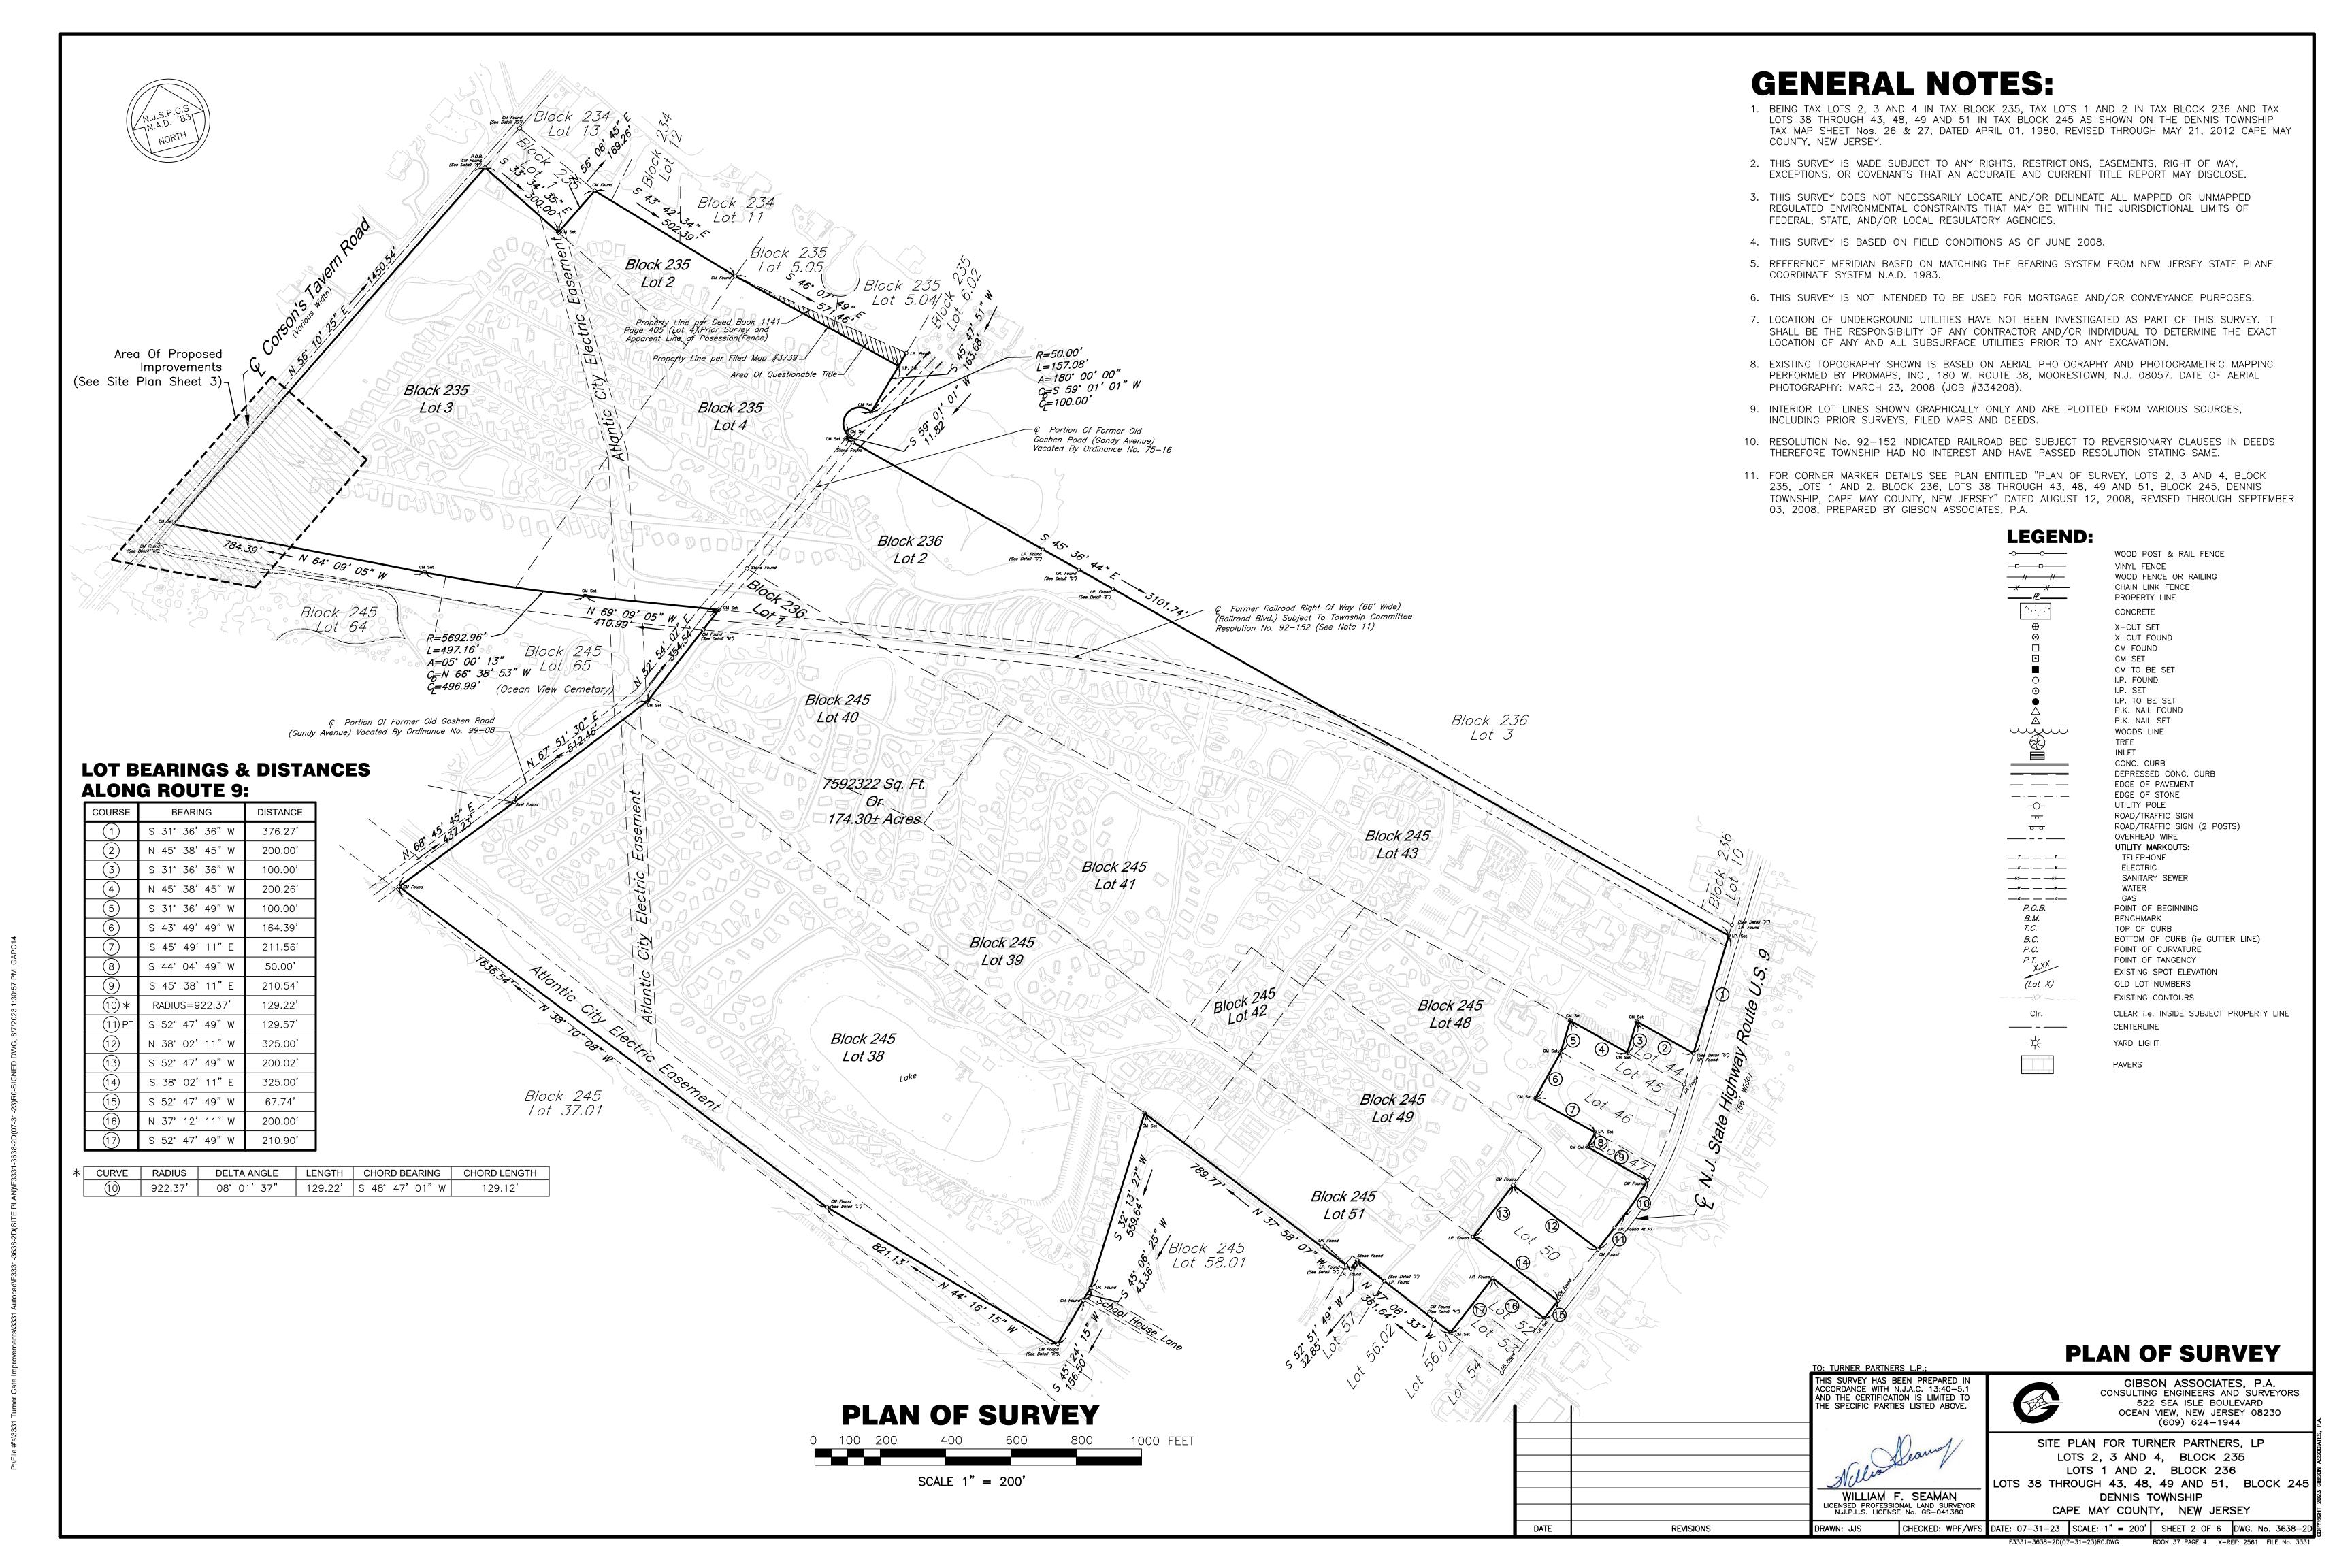

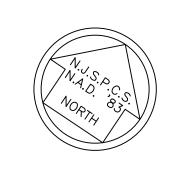


4'4" TO 6'4" SP, 10YR., 7/4, VERY PALE BROWN SAND, 0% GRAVEL, FINE FAINT MOTTLES, SUBANGULAR BLOCKY, FRIABLE.

ESTIMATE SEASONAL HIGH = $4'-1"\pm$

GROUND WATER = $7'-1"\pm$ (EL. 14.2)


6'4" TO 7'2" SP, 10YR., 7/4, VERY PALE BROWN COURSE SAND, 20% GRAVEL, FEW FINE FAINT MOTTLES, SUBANGULAR BLOCKY, FRIABLE.

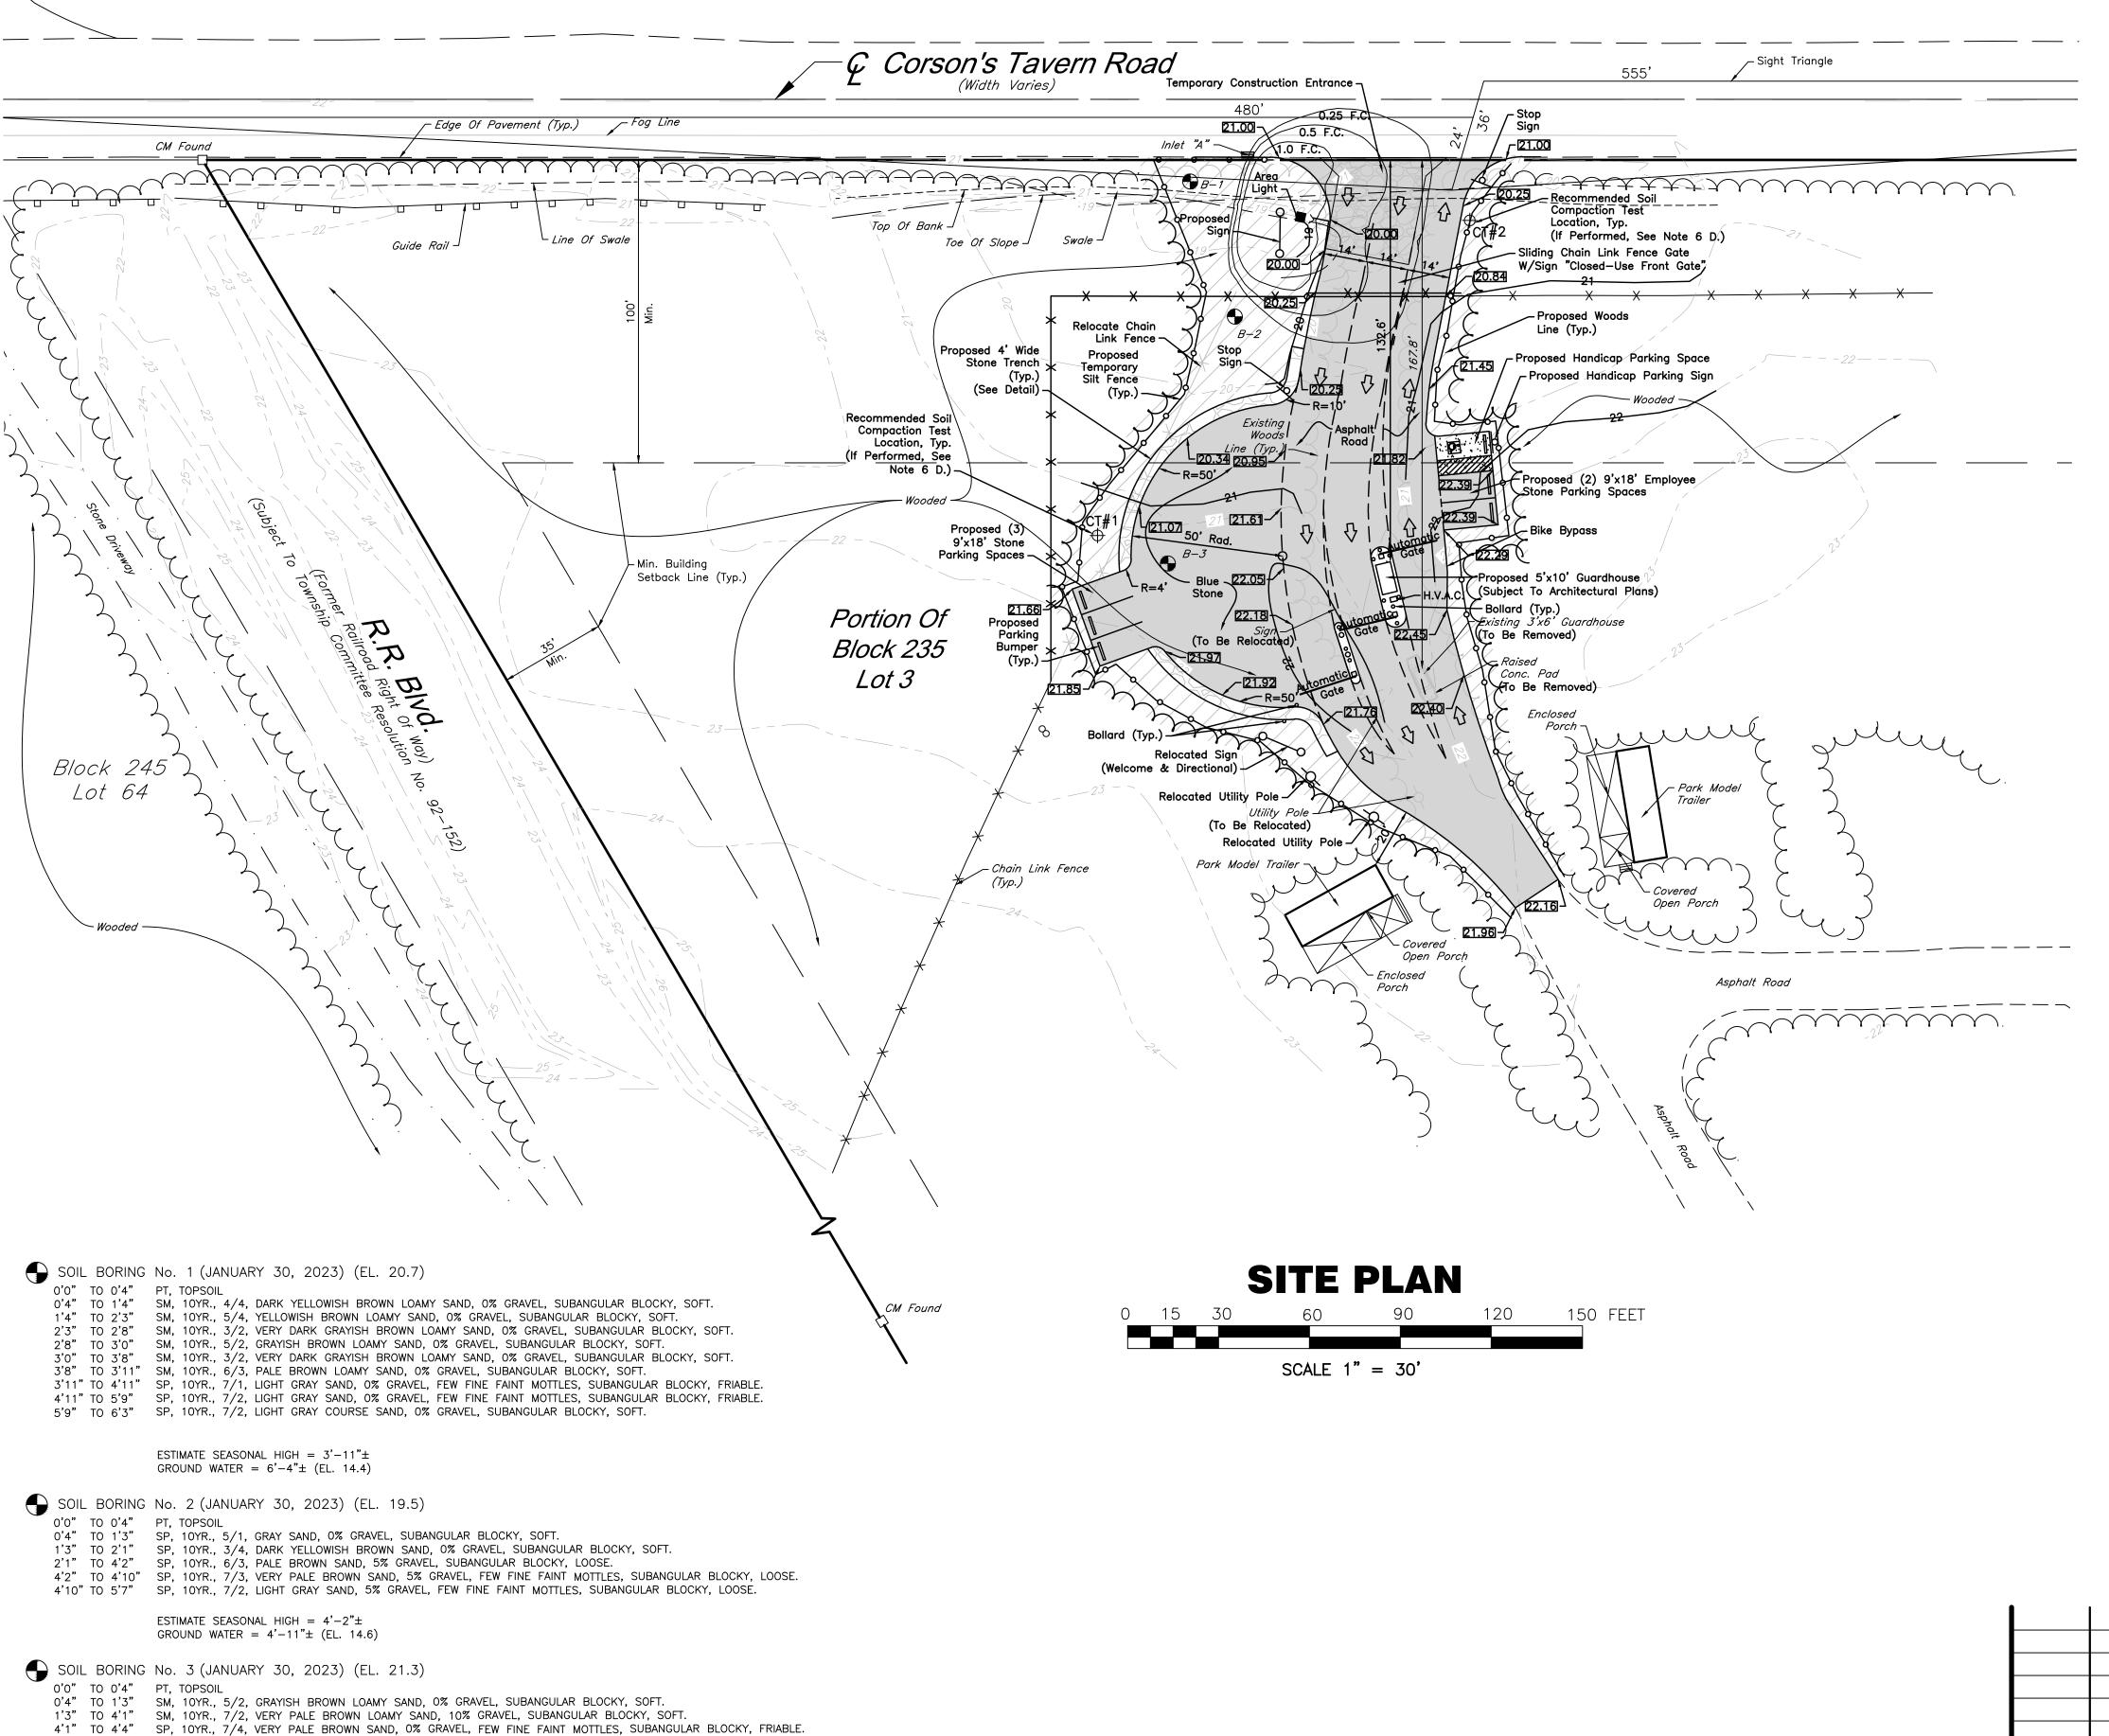

GENERAL NOTES:

- 1. VERTICAL CONTROL BASED ON N.A.V.D. 1988.
- 2. REFERENCE MERIDIAN BASED ON MATCHING THE BEARING SYSTEM FROM NEW JERSEY STATE PLANE COORDINATE SYSTEM N.A.D. 1983.
- 3. THIS PLAN IS BASED ON SURVEY BASE MAP ENTITLED "PLAN OF SURVEY, LOTS 2, 3 AND 4, BLOCK 235, LOTS 1 AND 2, BLOCK 236, LOTS 38 THROUGH 43, 48, 49 AND 51, BLOCK 245, DENNIS TOWNSHIP, CAPE MAY COUNTY, NEW JERSEY" DATED AUGUST 12, 2008, REVISED THROUGH SEPTEMBER 03, 2008, PREPARED BY GIBSON ASSOCIATES, P.A. EXISTING TOPOGRAPHY AND ELEVATIONS FOR THE AREA OF PROPOSED IMPROVEMENTS WAS UPDATED DURING THE MONTH OF DECEMBER 2022.
- 4. PROPOSED GUARDHOUSE BASED ON PLANS ENTITLED "OCEAN VIEW RESORT, REAR GUARDHOUSE, 2555 SHORE ROAD, OCEAN VIEW, NJ, DENNIS TOWNSHIP-BLOCK 235, LOT 3" DATED APRIL 05, 2023, PREPARED BY FENWICK
- 5. LIGHTING FOR GUARDHOUSE SHALL BE PROVIDED BY ARCHITECT.
- 6. TOPSOIL & SOIL DE-COMPACTION REQUIREMENTS:
- A. A MINIMUM OF 5 INCHES OF TOPSOIL IS REQUIRED ON AREAS TO BE VEGETATED TO IMPROVE THE SOIL MEDIUM FOR PLANT ESTABLISHMENT AND MAINTENANCE PER CHAPTER 5 OF THE "STANDARDS FOR SOIL EROSION AND SEDIMENT CONTROL IN NEW JERSEY". JULY 2017.
- B. SUBGRADE SOILS SHALL BE FREE OF EXCESSIVE COMPACTION TO A DEPTH OF 6 INCHES TO ENHANCE THE ESTABLISHMENT OF PERMANENT VEGETATIVE COVER PER CHAPTER 19 OF THE "STANDARDS FOR SOIL EROSION AND SEDIMENT CONTROL IN NEW JERSEY", JULY 2017.
- C. SUBSOILS ARE TO BE PROACTIVELY DE-COMPACTED OR SOIL COMPACTION TESTED PRIOR TO THE APPLICATION OF TOPSOIL. COMPACTION TESTING METHOD/PRODECURE SHALL BE PERFORMED PER CHAPTER 19 BY THE CONTRACTOR OR OTHER PROJECT OWNER'S REPRESENTATIVE. IF THE TESTING INDICATES SUBSOIL COMPACTION, THE SUBSOIL SHALL BE DE-COMPASCTED TO A DEPTH OF 6 INCHES PRIOR TO THE APPLICATION OF TOPSOIL.
- D. IF COMPACTION TESTING IS <u>NOT</u> PERFORMED, SUBSOILS SHALL BE SCARIFIED/TILLED TO A MINIMUM DEPTH OF 6 INCHES AS PART OF THE SEQUENCE OF CONSTRUCTION WHERE THERE IS NO DANGER TO UNDERGROUND UTILITIES (CABLES, IRRIGATION SYSTEMS, ETC.). IN THE ALTERNATIVE, ANOTHER MÈTHOD AS SPECIFIED BY A NEW JERSEY LICENSED PROFESSIONAL ENGINEER MAY BE SUBSTITUTED SUBJECT TO DISTRICT APPROVAL.
- 7. VEGETATIVE COVER:
- A. SITE MUST BE PROPERLY MULCHED FOR NON-GROWING SEASONS USING STRAW MULCH AT 90-115 LBS./1000 SQ. FT. (3 BALES), PROPERLY ANCHORED OR TACKED.
- B. WHEN REQUIRED, SITE MUST BE SEEDED TO ESTABLISH A TEMPORARY VEGETATIVE COVER. PERENNIAL RYEGRASS AT 1 LB./1000 SQ. FT. MAY BE
- C. PREPARE AREAS TO BE PERMANENTLY SEEDED BY TOPSOILING (A MINIMUM OF 5" IS REQUIRED), FERTILIZING AT 11 LBS./1000 SQ. FT. OF 10-20-10, AND APPLYING LIME AT 90 LBS./1000 SQ. FT.
- D. SEED THE SITE TO ESTABLISH A PERMANENT VEGETATIVE COVER UTILIZING A TURF-TYPE TALL FESCUE/PERENNIAL RYEGRASS MIX AT 6-8 LBS./1000 SQ. FT., OR EQUIVALENT. APPLY STRAW MULCH AT 70-90 LBS./1000 SQ. FT. (2 BALES), AND ANCHOR OR TACK. SOD, STONE COVER OR MULCHED LANDSCAPE BEDS MAY BE SUBSTITUTED FOR SEEDING TO ESTABLISH A PERMANENT COVER.

LEGEND:

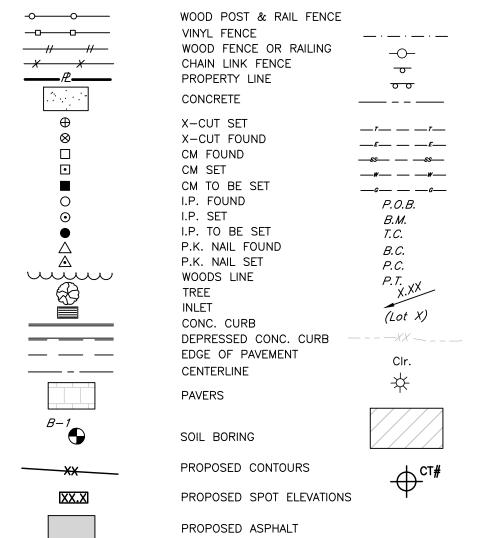


UTILITY POLE ROAD/TRAFFIC SIGN (1 POST) ROAD/TRAFFIC SIGN (2 POSTS) OVERHEAD WIRE UTILITY MARKOUTS: TELEPHONE ELECTRIC SANITARY SEWER WATER POINT OF BEGINNING BENCHMARK TOP OF CURB BOTTOM OF CURB (ie GUTTER LINE) POINT OF CURVATURE POINT OF TANGENCY EXISTING SPOT ELEVATION OLD LOT NUMBERS EXISTING CONTOURS CLEAR i.e. INSIDE SUBJECT PROPERTY LINE YARD LIGHT

EDGE OF STONE

AREA SUBJECT TO SOIL DE-COMPACTION (9935 SQ. FT.)

COMPACTION TEST LOCATION

SITE PLAN

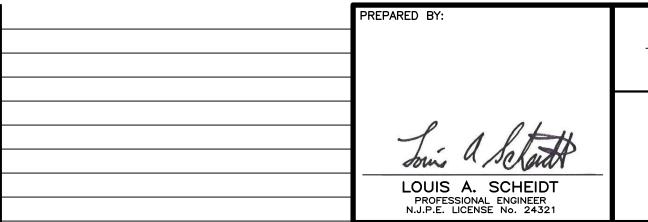


REVISIONS

GIBSON ASSOCIATES, P.A. CONSULTING ENGINEERS AND SURVEYORS 522 SEA ISLE BOULEVARD OCEAN VIEW, NEW JERSEY 08230 (609) 624-1944

SITE PLAN FOR TURNER PARTNERS, LP PORTION OF LOT 3, BLOCK 235 DENNIS TOWNSHIP


CAPE MAY COUNTY, NEW JERSEY

CHECKED: WPF/WFS DATE: 07-31-23 | SCALE: 1" = 30' | SHEET 3 OF 6 | DWG. No. 3638-21

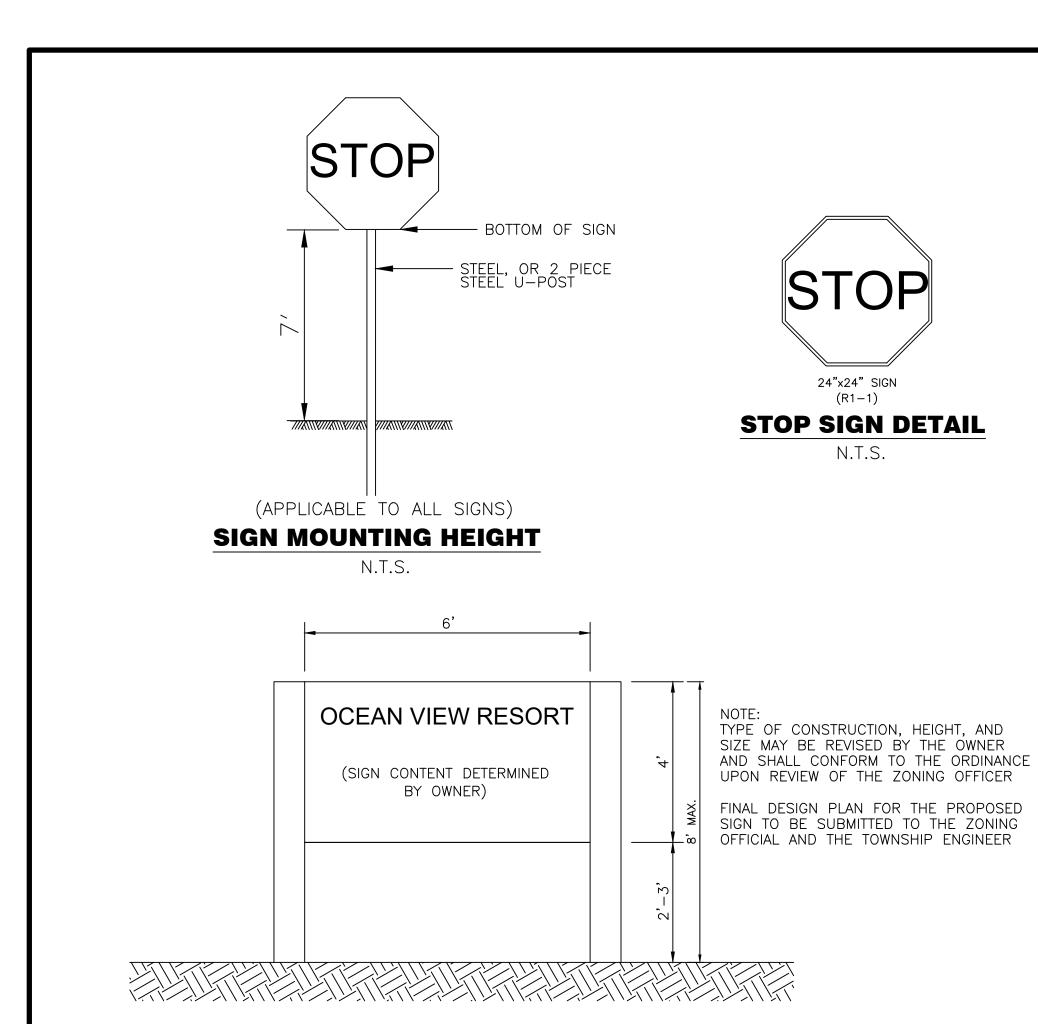

SIGN DETAIL

N.T.S.

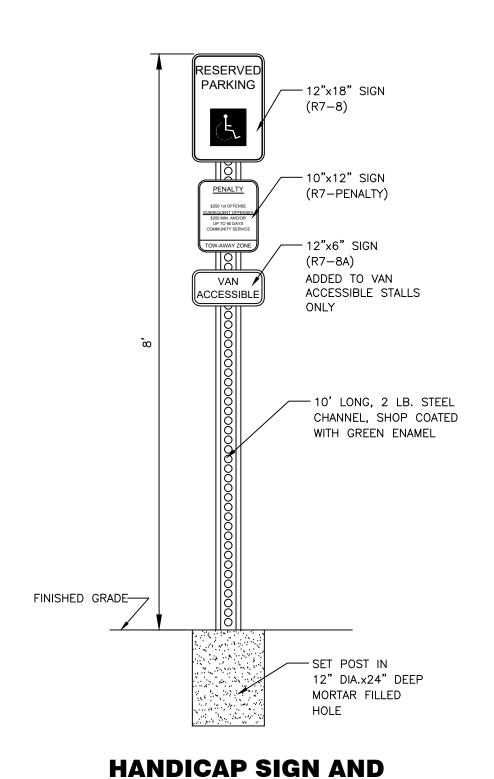

SIGN POST DETAIL

N.T.S.



(AREA WITH REFRACTOR)

15° TILT, 15 FT. HEIGHT (POLE MOUNTED)

UNIT TO HAVE PHOTOCONTROL AND

PROGRAMMABLE CAPABILITIES.


FRONT

2' LONG # 4 REBAR (MIN. TYP.)

PARKING BUMPER


N.T.S.


SIDE

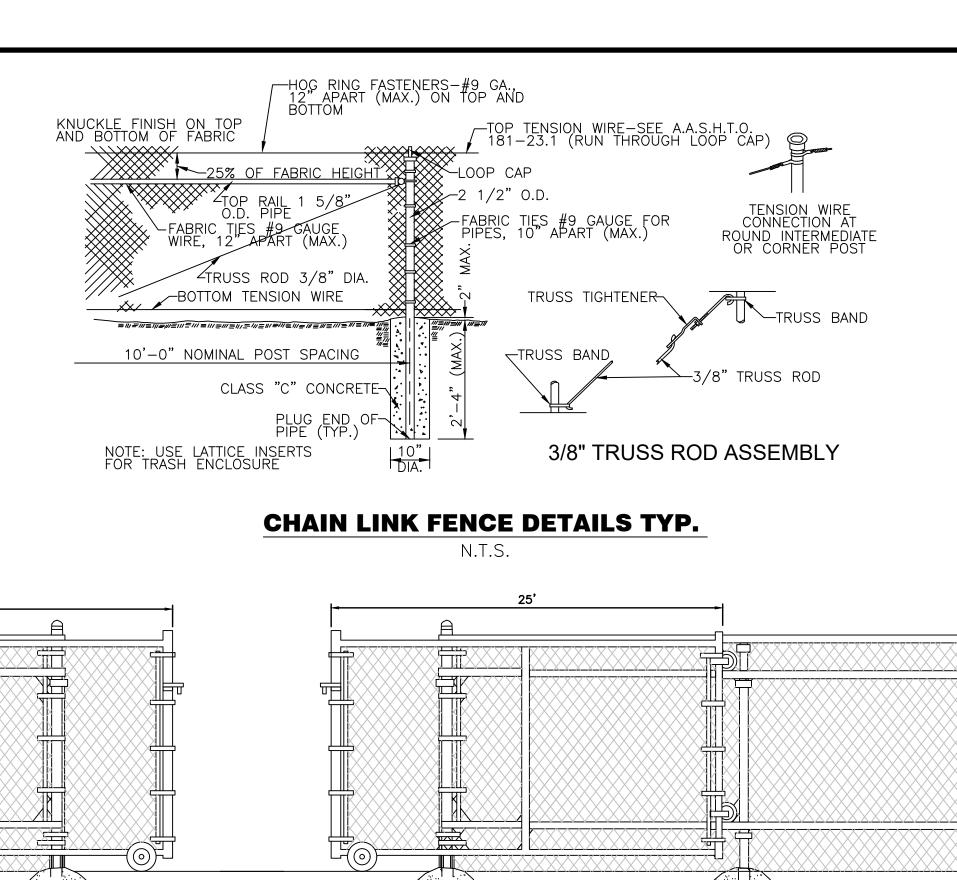

6' HIGH CHAIN LINK FENCE SLIDING GATE

N.T.S.

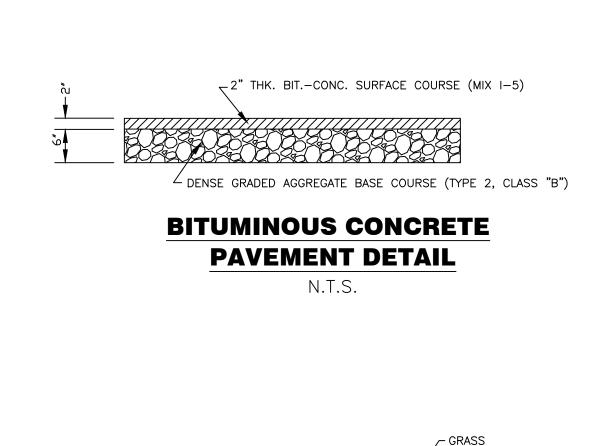

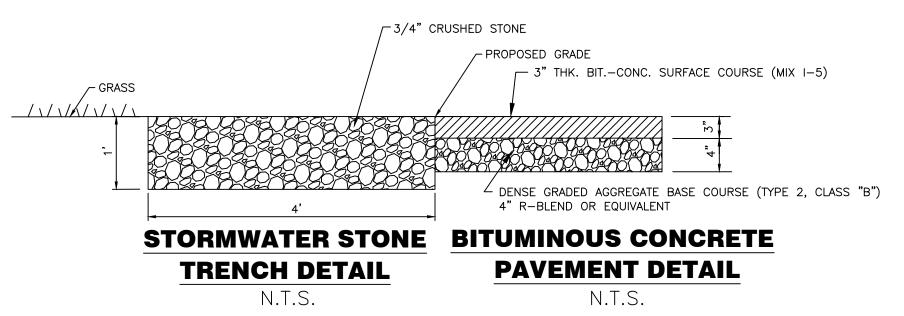

DETAILS

PREPARED BY:

GIBSON ASSOCIATES, P.A.

CONSULTING ENGINEERS AND SURVEYORS
522 SEA ISLE BOULEVARD
OCEAN VIEW, NEW JERSEY 08230
(609) 624–1944

SITE PLAN FOR TURNER PARTNERS, LP
PORTION OF LOT 3, BLOCK 235

DENNIS TOWNSHIP
CAPE MAY COUNTY, NEW JERSEY

DATE

DATE

REVISIONS

DRAWN: JJS

CHECKED: WPF/WFS

DATE: 07–31–23

SCALE: AS SHOWN
SHEET 4 OF 6

DWG. No. 3638–200

ADJACENT PROPERTY OWNERS WITHIN 200':

UTILITIES:

LEE ANN RUSS, CTA

RECEIVED
JUN 0 8 2023

TOWNSHIP OF DENNIS

Tax Assessment Department
571 Petersburg Road
P.O. Box 204
Dennisville, NJ 08214

Phone: (609) 861-9700 ext. 241
Fax: (609) 861-9719

June 5, 2023

June

GIBSON ASSOCIATES P.A
THIS IS TO CERTIFY THAT THE FOLLOWING LIST OF PROPERTY OWNERS ARE
WITHIN 200 FEET OF BLOCK 235 LOT 3 ACCORDING TO THE OFFICIAL TAX MAP OF
DENNIS TOWNSHIP.

ATTEST LEE ANN RUSS, CTA

BLOCK 235 LOT 3

CAPE MAY COUNTY PLANNING BOARD DN-309, CENTRAL MAIL ROOM CAPE MAY COURT HOUSE, NJ 08210

VERIZON COMMUNICATIONS % ENGINEERING DEPARTMENT 10 TANSBORO RD, FL 2 BERLIN, NJ 08009

SOUTH JERSEY GAS COMPANY
% JOSEPH SCHNEIDER
GENERAL MANAGER
SYSTEM ENGINEERING & PLANNING
1 SO JERSEY PLAZA
FOLSOM, NJ 08037

CONECTIV REAL ESTATE DEPARTMENT 5100 HARDING HIGHWAY, SUITE 399 MAYS LANDING, NJ 08330-9902

(CONTINUED)

LEE ANN RUSS, CTA
Tax Assessor

P.O. Box 204 Dennisville, NJ 08214 Phone: (609) 861-9700 ext. 241 Fax: (609) 861-9719

TOWNSHIP OF DENNIS

Tax Assessment Department

571 Petersburg Road

THE THE HEAD OF CAPE

PAGE 2 RE: BLOCK 235 LOTS 3

COMCAST CABLE
901 W LEEDS AVENUE
ABSECON, NJ 08201

PUBLIC SERVICE ELECTRIC & GAS CO.
MANAGER-CORPORATE PROPERTIES
80 PARK PLAZA, T6B
NEWARK, NJ 07102

CAPE ATLANTIC SOIL
CONSERVATION DISTRICT
ATTN: MICHAEL KENT

6260 OLD HARDING HIGHWAY

MAYS LANDING, NJ 08330

BLOCK	LOT	QUAL	PROPERTY OWNER & MAILIN PROPERTY LOCATION	IG ADDRESS	P
225.01	1		SEA QUEST ENTERPRISES LI PO BOX 607 OCEAN VIEW, NJ CORSON TAVERN RD		
225.01	10.01		DEVER, MATTHEW & PATRICI 300 47TH PLACE SEA ISLE CITY, NJ 353 CORSON TAVERN RD		
225.01	10.02		MAUND, BRIAN & SANDRA G 363 CORSON TAVERN RD OCEAN VIEW, NJ 363 CORSON TAVERN RD	08230.1059	
225.01	10.03		DEVER, DANIEL O & JOANN 373 CORSON TAVERN RD OCEAN VIEW, NJ 373 CORSON TAVERN RD	08230.1059	
225.01	10.04		SCHALL, FREDERICK R JR & 383 CORSON TAVERN RD OCEAN VIEW, NJ 383 CORSON TAVERN RD	JOANNE M 08230.1059	
234	11		TURNER, SCOTT J & KELLIL 16 DOROTHY LA OCEAN VIEW, NJ 12 DOROTHY LA		
234	12		TURNER, SCOTT J & KELLIL 16 DOROTHY LA OCEAN VIEW, NJ 16 DOROTHY LA		
234	13		MAHONEY, WINIFRED A&POUDR 10 DOROTHY LA OCEAN VIEW, NJ 10 DOROTHY LA		
234	14		GUEST, EDWARD R JR & THE 386 CORSON TAVERN RD OCEAN VIEW, NJ 386 CORSON TAVERN RD	RESA A 08230.1022	
235	1		OAKLEY, ELEANOR 382 CORSON TAVERN RD OCEAN VIEW, NJ 382 CORSON TAVERN RD	08230.1022	
235	2		TURNER PARTNERS LP PO BOX 607 OCEAN VIEW, NJ CORSON TAVERN RD-REAR	08230.0607	
235	4		TURNER PARTNERS LP PO BOX 607 OCEAN VIEW, NJ 240 OLD GOSHEN RD	08230.0607	
245	64		TURNER PARTNERS LP PO BOX 607 OCEAN VIEW, NJ 308 CORSON TAVERN RD	08230.0607	
245	65		OCEAN VIEW CEMETERY COMPA PO BOX 607 OCEAN VIEW, NJ 253 OLD GOSHEN RD	NY 08230.0607	
247	15.12	QFARM	D & B TURF LLC PO BOX 130 SOUTH SEAVILLE, NJ 353 CORSON TAVERN RD	08246.0130	

200' LIST

		PREPARED BY:		GIBSON ASSOCIATES, P.A. CONSULTING ENGINEERS AND SURVEYORS 522 SEA ISLE BOULEVARD OCEAN VIEW, NEW JERSEY 08230 (609) 624-1944				
		Louis a	Schart		PLAN FOR TUR	3, BLOCK	•	
		LOUIS A. PROFESSIONA	AL ENGINEER	CAPE	DENNIS T MAY COUN		ERSEY	
ATE	REVISIONS	DRAWN: JJS	CHECKED: WPF/WFS	DATE: 07-31-23	SCALE: AS SHOWN	SHEET 5 OF 6	DWG. No. 3638-2D	

- I. NARRATIVE:
- THE APPLICANT IS PROPOSING TO CONSTRUCT THE PROPOSED IMPROVEMENTS SHOWN ON THE PRECEEDING PLANS. CONSTRUCTION SHALL COMMENCE UPON ISSUANCE OF ALL REQUIRED PERMITS AND/OR APPROVALS. THE CAPE-ATLANTIC CONSERVATION DISTRICT SHALL BE NOTIFIED OF THE STARTING DATE FOR WORK SHOWN HEREON.
- II. SEQUENCE OF DEVELOPMENT:
- A. NOTIFY THE DISTRICT PRIOR TO SITE DISTURBANCE.
- B. DEMOLITION OF CONCRETE.
- C. INSTALL TEMPORARY STABILIZED CONSTRUCTION ENTRANCE ON COLUMBIA AVENUE.
- D. INSTALL TEMPORARY SILT FENCE, SEDIMENT AND TRAFFIC CONTROL BARRIER.
- E. INSTALL INLET FILTER AT EXISTING INLET
- F. COMMENCE CLEARING AND ROUGH GRADING OPERATIONS.
- G. COMMENCE SITE CONSTRUCTION.
- H. PERMANENT VEGETATIVE STABILIZATION AND LANDSCAPING.
- I. COMPLIANCE INSPECTION.
- III. SOIL EROSION AND SEDIMENT CONTROL FACILITIES:
- A. TEMPORARY STABILIZED CONSTRUCTION ENTRANCE TO BE INSTALLED IN ACCORDANCE WITH SECTION 27-1 OF THE STANDARDS*.
- B. TEMPORARY SILT FENCE SEDIMENT CONTROL BARRIER TO BE INSTALLED IN ACCORDANCE WITH SECTION 23-1(C) OF THE STANDARDS*.
- C. TEMPORARY INLET FILTER TO BE INSTALLED IN ACCORDANCE WITH SECTION 28-1 OF THE STANDARDS*.
- D. TEMPORARY STABILIZATION TO BE INSTALLED IN ACCORDANCE WITH SECTION 7-1 OF THE STANDARDS*.
- E. PERMANENT VEGETATIVE STABILIZATION TO BE INSTALLED IN ACCORDANCE WITH SECTION 4-1 OF THE STANDARDS*.
- IV. SOIL EROSION AND SEDIMENT CONTROL PROCEDURES:
- A. TEMPORARY STABILIZATION WITH MULCH ONLY:
- ALL DISTURBED AREAS LEFT EXPOSED LESS THAN (2) MONTHS OR WHEN SEASONS OR OTHER CONDITIONS ARE NOT SUITABLE FOR GROWING OR TEMPORARY VEGETATIVE COVER (OCTOBER 31ST. THROUGH FEBRUARY 14th. AND MAY 1ST. THROUGH AUGUST 14th.) WILL BE STABILIZED WITH MULCH TO MINIMIZE DAMAGE FROM WIND AND/OR WATER EROSION.

GENERAL NOTES:

RIGHT-OF-WAYS MUST BE

BETWEEN PROPOSED LAND

CONSERVATION DISTRICT

MUST BE MADE FIVE (5)

CERTIFICATES.

DISTURBANCE AREA AND PAVED ROADS.

MUNICIPALITY. A REQUEST FOR A

AND CONDITIONAL (TEMPORARY)

SEDIMENTATION THAT MAY OCCUR

CONSTRUCTION OF THE PROJECT.

1. ALL SEDIMENT SPILLED, DROPPED, WASHED OR TRACKED ONTO PUBLIC

REMOVED IMMEDIATELY. INSTALL A STABILIZED CONSTRUCTION ENTRANCE

2. A REPORT OF COMPLIANCE MUST BE OBTAINED FROM THE CAPE-ATLANTIC

DISTRICT INSPECTION FOR THE RELEASE OF A REPORT OF COMPLIANCE


WORKING DAYS IN ADVANCE. THIS APPLIES TO BOTH COMPLETE (FINAL)

3. THE PROPERTY OWNER SHALL BE RESPONSIBLE FOR ANY EROSION OR

BELOW STORMWATER OUTFALLS OR OFF SITE AS A RESULT OF


PRIOR TO RECEIVING A CERTIFICATE OF OCCUPANCY FROM THE

- 2. STABILIZATION WITH MULCH, INCLUDING ANCHORING TECHNIQUES, SHALL COMPLY WITH SECTION 7-1 OF THE STANDARDS*.
- TEMPORARY STABILIZATION WITH VEGETATIVE COVER:
- 1. ALL DISTURBED AREAS LEFT EXPOSED FOR A PERIOD OF (2) TO (12) MONTHS WILL BE STABILIZED WITH EITHER ANNUAL OR PERENNIAL RYEGRASS TO MINIMIZE DAMAGE FROM WIND AND/OR WATER EROSION.
- RYEGRASS TO BE APPLIED AT THE RATE OF 2.5 LBS./1000 SQUARE FEET. 10-0-10 OR EQUIVALENT FERTILIZER SHALL BE APPLIED AT THE RATE OF 11 LBS./1000 SQUARE FEET.
- FERTILIZER AND LIME SHALL BE WORKED INTO THE SOIL TO A DEPTH OF (4) INCHES PRIOR TO SEEDING OPTIMUM SEEDING DEPTH TO BE (1) INCH FOR SANDY SOILS.
- MULCHING IS REQUIRED IMMEDIATELY AFTER SEEDING IS COMPLETE. MULCH MAY BE UNROTTED SMALL GRAIN STRAW, HAY FREE OF SEED, OF SALT HAY APPLIED AT THE RATE OF 70 TO 90 LBS./1000 SQUARE FEET AND ANCHORED IMMEDIATELY AFTER PLACEMENT TO MINIMIZE LOSS BY WIND AND/OR WATER EROSION.
- 5. TEMPORARY SEEDING DATES SHALL BE FEBRUARY 15th. THROUGH MAY 1st. AND AUGUST 15th. THROUGH OCTOBER 15th.
- 6. TEMPORARY VEGETATIVE COVER, INCLUDING ANCHORING TECHNIQUES, SHALL COMPLY WITH SECTION 16-1 OF THE STANDARDS*.
- C. DUST CONTROL:
- WHEN CONDITIONS EXIST DURING CONSTRUCTION THAT EXPOSED SOIL SURFACES EXHIBIT DUST BLOWING AND MOVEMENT, WHERE ON AND OFF SITE DAMAGE IS LIKELY, THOSE AREAS SHALL BE STABILIZED TO CONTROL THE DUST.
- THE CONTRACTOR SHALL KEEP A WATER TRUCK ON SITE FOR CONTROL OF DUST. THE CONTRACTOR SHALL CONTROL DUST ON A DAILY BASIS ON ANY INTERNAL CIRCULATION ROADS UTILIZED DURING CONSTRUCTION AND AREAS NOT TEMPORARILY STABILIZED.
- 3. CONTROL OF DUST, SHALL COMPLY WITH SECTION 16-1 OF THE STANDARDS*.
- V. SOIL STOCKPILES:
- 1. SILT FENCE SHALL BE PLACED AROUND ALL SOIL STOCKPILES.
- 2. SOIL STOCKPILES SHALL BE STABILIZED ACCORDING TO SECTIONS IV.A OR IV.B AS DESCRIBED ABOVE.
- VI. REFERENCES AND/OR ACCOMPANYING SUPPORTING DATA:
 - * "STANDARDS FOR SOIL EROSION AND SEDIMENT CONTROL IN NEW JERSEY", JULY 2017.
 - MAINTENANCE SCHEDULE FOR STORMWATER MANAGEMENT SYSTEM:
- 1. A VISUAL INSPECTION OF ALL COMPONENTS OF THE SYSTEM AT LEAST TWICE A YEAR.
- REMOVAL OF ANY SILT, SOIL, LITTER, AND OTHER DEBRIS FROM TRENCH DRAINS AND UNDERGROUND PIPES AT LEAST TWICE A YEAR. FREQUENCY MAY BE ADJUSTED IF THE FIRST YEAR MAINTENANCE RECORDS INDICATE THAT SEDIMENT AND DEBRIS ACCUMULATION IS INSIGNIFICANT.
- REGULAR SEASONAL WORK; MOWING, FERTILIZING, LIMING, WEED AND PEST CONTROL, RESEEDING AND TIMELY REPAIRS OF VEGETATIVE AREAS. VEGETATIVE MAINTENANCE SHALL COMPLY WITH SECTION 3-1 OF THE STANDARDS*.
- 4. IF SAND AND GRAVEL ARE USED ON PAVEMENTS DURING WINTER STORMS FOR SAFETY REASONS, PAVED AREAS SHOULD BE SWEPT AFTER SNOW AND ICE REMOVAL TO PREVENT SEDIMENT BUILD-UP IN THE DRAINAGE SYSTEM.
- 5. THE PROPERTY OWNER WILL BE RESPONSIBLE FOR INSPECTION AND MAINTENANCE OF THE STORMWATER MANAGEMENT SYSTEM.

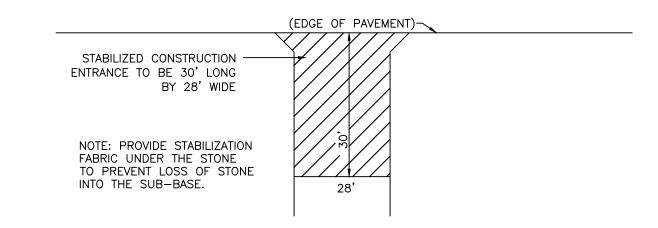

DETAIL OF TEMPORARY STABILIZED CONSTRUCTION ENTRANCE

N.T.S.

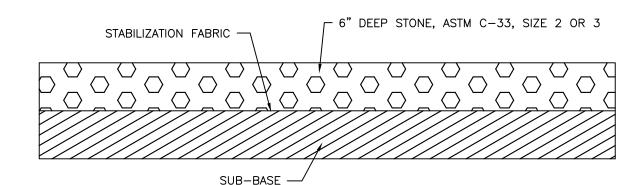


SECTION OF TEMPORARY STABILIZED CONSTRUCTION ENTRANCE N.T.S.

DRAWSTRING RUNNING -THROUGH FABRIC ALONG TOP OF FENCE 1-1/2" DIA. MIN. FENCE POSTS AT 8'0" O.C. FILTER FABRIC — FABRIC SECURED TO POST — WITH METAL FASTENERS AND REINFORCEMENT BETWEEN FASTENER AND FABRIC BACKFILL WITH GRAVEL -AFTER FILTER FABRIC IS PLACED IN 6" MIN. DEEP TRENCH BURY BOTTOM FLAT, TAMP IN PLACE SILT ACCUMULATION — EXISTING GRADE —

TEMPORARY SILT FENCE DETAIL

N.T.S.

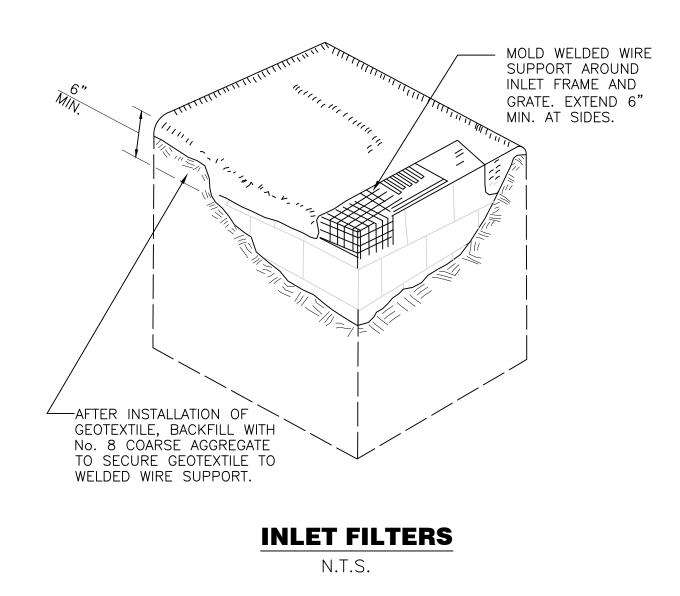

SOIL EROSION & SEDIMENT CONTROL PLAN

		PREPARED BY:		
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		some a	SCHOUTH	
		LOUIS A.		
		PROFESSIONA N.J.P.E. LICENS	AL ENGINEER SE No. 24321	
DATE	REVISIONS	DRAWN: JJS	CHECKED: WPF/WFS	DATE: (

GIBSON ASSOCIATES, P.A. CONSULTING ENGINEERS AND SURVEYORS 522 SEA ISLE BOULEVARD OCEAN VIEW, NEW JERSEY 08230 (609) 624-1944

SITE PLAN FOR TURNER PARTNERS, LP PORTION OF LOT 3, BLOCK 235 DENNIS TOWNSHIP CAPE MAY COUNTY, NEW JERSEY

CHECKED: WPF/WFS DATE: 07-31-23 | SCALE: AS SHOWN | SHEET 6 OF 6 | DWG. No. 3638-20