



Township of Dennis
Block 81.01, Lot 3.01 Sheet 18
Tax Map
1" = 500'

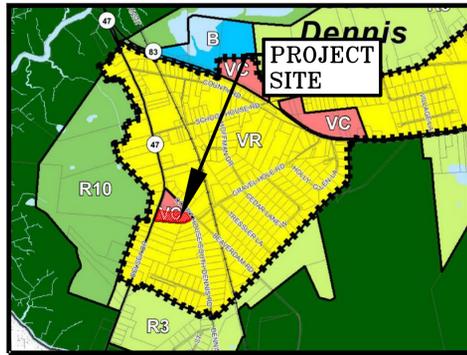

Township of Dennis
Located in the Village Commercial District
Zoning Map
1" = 2000'

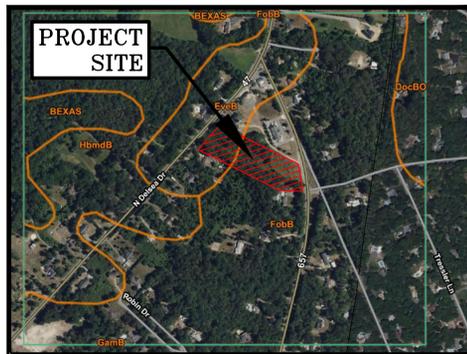

USDA Web Soil Survey
Soils Map
N.T.S.

200' List

Block 79, Lot 15	Bridget M Baylock 930 Court House S Dennis Road Cape May Court House, NJ 08210
Block 79, Lot 16	Thomas F Jr & Schmidt A G Macellaro 924 Court House S Dennis Road Cape May Court House, NJ 08210
Block 79, Lot 17	Joanne & James Horn 1 Beaver Dam Road Cape May Court House, NJ 08210
Block 79, Lot 18	Unknown Owner Beaver Dam Road Dennisville, NJ 08214
Block 80, Lot 21.02	Paul I Young 787 Route 47, PO Box 148 South Dennis, 08245
Block 80, Lot 22.01	Louis Altobelli PO Box 95 Cape May Court House, NJ 08210
Block 80, Lot 22.02	Jacky Jr Varner 761 Route 47 N Cape May Court House, NJ 08210
Block 80, Lot 23	John Fisher 225 Fremont Ave Woodbine, NJ 08270
Block 80, Lot 24	Richard S G & Waneita R Keen PO Box 115 Delsea Drive South Dennis, NJ 08245
Block 81.01, Lot 1	Manjit Singh 1206 Georgia Ave Cape May Court House, 08210
Block 81.01, Lot 2.01	Michael S & Ritcher, Jamie Bennett 770 Route 47 N Cape May Court House, NJ 08210
Block 81.01, Lot 2.02	Arc of Cape May County PO Box 255 South Dennis, NJ 08210
Block 81.01, Lot 4.01	William M III & Caroline Szathmary 750 Route 47 N Cape May Court House, NJ 08210
Block 81.01, Lot 4.02	James J & Sally A Springer 744 Route 47 N Cape May Court House, NJ 08210
Block 81.01, Lot 4.06	Michael G Jr & Michelle E Paluch 907 Court House S Dennis Road Cape May Court House, NJ 08210
Block 81.01, Lot 4.07	Kevin E & Robin Rudok PO Box 228 South Dennis, NJ 08245
Block 82, Lot 1.01	Gerald J Jr & Maureen A Gibboni 303 Gravel Hole Road Cape May Court House, NJ 08210
Block 83, Lot 1	Page D & Samantha C Gibson 898 Court House S Dennis Road Cape May Court House, NJ 08210
DN-309, Central Mail Room	Comcast Cable 901 W Leeds Avenue Absecon, NJ 08201
Verizon Communications Engineering Department 10 Tansboro Road, Floor 2 Berlin, NJ 08009	Public Service Electric & Gas Co. Manager-Corporate Properties 80 Park Plaza, T6B Newark, NJ 07102
South Jersey Gas Company Joseph Schneider ATTN: Michael Kent General Manager System Engineering & Planning 1 So Jersey Plaza Folsom, NJ 08037	Cape Atlantic Soil Conservation District ATTN: Michael Kent 6260 Old Harding Highway Mays Landing, NJ 08530
Connectiv Real Estate Department 5100 Harding Highway, Suite 399 Mays Landing, NJ 08530-9902	State of NJ-Dot CN-600 1035 Parkway Ave Trenton, NJ 08625-0600

Major Site Plan

760 Route 47 North

Cape May County, New Jersey

Block 81.01, Lot 3.01

PM Pools and Spa



NJ Geo-Web
2020 Natural Color Imagery
Key Map
1" = 1000'



Kates Schneider Engineering, LLC
Engineers • Surveyors • Planners

215 Route 9 South
Marmora, New Jersey 08223
(609) 365-1747

Village Commercial (VC) Requirements Dennis Township, New Jersey				
Existing Use: Vacant; Proposed Use: Commercial				
	Bulk Requirements	Existing Lot 3.01	Proposed Lot 3.01	Conformance
Zoning Requirements				
Minimum Lot Size	35,000 SF	3 Acres	3 Acres	Conforming
Minimum Lot Width	100 FT	276.36 FT	276.36 FT	Conforming
Minimum Lot Depth	200 FT	457 FT	457 FT	Conforming
Maximum Front Yard - Primary	8 FT	--	124.5 FT*	Non-Conforming-
Maximum Front Yard - Secondary	4 FT	--	510 FT*	Variance Required
Minimum Side Yard	20 FT	--	75.4 FT	Conforming
Minimum Rear Yard	55 FT	--	242.6 FT	Conforming
Maximum Total Building Coverage	35%	--	3.4%	Conforming
Maximum Impervious Coverage	60%	--	16%	Conforming
Parking Requirements				
Parking Buffer to Right-of-Way (Route 47)	50 FT	--	54 FT	Conforming
Parking Buffer to Side Property Line	10 FT	--	75 FT	Conforming
Parking Buffer to Rear Property Line	10 FT	--	342.6 FT	Conforming

Index of Drawings	
Sheet	Description
1	Cover
2	Existing Conditions & Demolition Plan
3	Site Plan
4	Grading & Drainage Plan
5	Pre-Development Drainage Area
6	Post-Development Drainage Area
7	Landscape & Lighting Plan
8	Landscape & Lighting Details
9	Soil Erosion & Sediment Control Plan
10	Soil Erosion & Sediment Control Details
11	Construction Details

General Notes

- The referenced meridian is NVD29 for the vertical control and NAD83 for the horizontal control.
- The referenced coordinate system is the New Jersey State Plane system.
- I hereby certify that to the best of my knowledge and belief this map and land survey dated January 28, 2025 meets the minimum survey detail requirements of the State Board of Professional Engineers and Land Surveyors and the map has been made under my supervision, and complies with the "Map Filing Law". The monuments shown on this map shall be set within the time limit provided in the municipal land use law, "P.L. 1975, C291 (C.40:55D-1 et seq.) or local ordinance.

Gregory K. Schneider 6/4/25
Date

Gregory K. Schneider
Professional Engineer & Land Surveyor
NJ License No. 42577

4. Township of Dennis Approval:

Chairman _____ Date _____

Secretary _____ Date _____

City Engineer _____ Date _____

Survey Notes

- Record Owner/Site Address:
CAM Management, LLC
760 Route 47 North
Dennis Township, NJ 08210
- Applicant/Applicant's Address:
PM Pools and Spa, LLC
376 96th Street
Stone Harbor, NJ 08247
- Source of title:
Book 3863, Page 232
Block 81.01, Lot 3.01
- Boundary and Physical Improvements shown are from a field survey by Kates Schneider Engineering performed on January 28, 2025.
- This survey was performed without the benefit of a current title report, which would disclose any rights, reservations, easements, etc. of record.
- According to a site inspection and National Wetlands Inventory Mapper, there are no wetlands or wetland buffers located on site.
- Project scope consists of a 4,500 sf of commercial building, gravel storage/equipment parking and asphalt customer parking lot.


Parking Requirements

Warehouse Use:
1 space per 1,000 sf of GFA -->
proposed GFA = 2,750 sf, therefore 3 spaces are required.

1 space per vehicle owned/operated by the use operating from the site. --> 1 employee max per shift, therefore 1 space is required.

Retail Use:
5 spaces per 1,000 sf of GFA -->
proposed GFA = 1,250 sf, therefore 6 spaces are required.

TOTAL SPACES REQUIRED=10
TOTAL SPACES PROPOSED=14

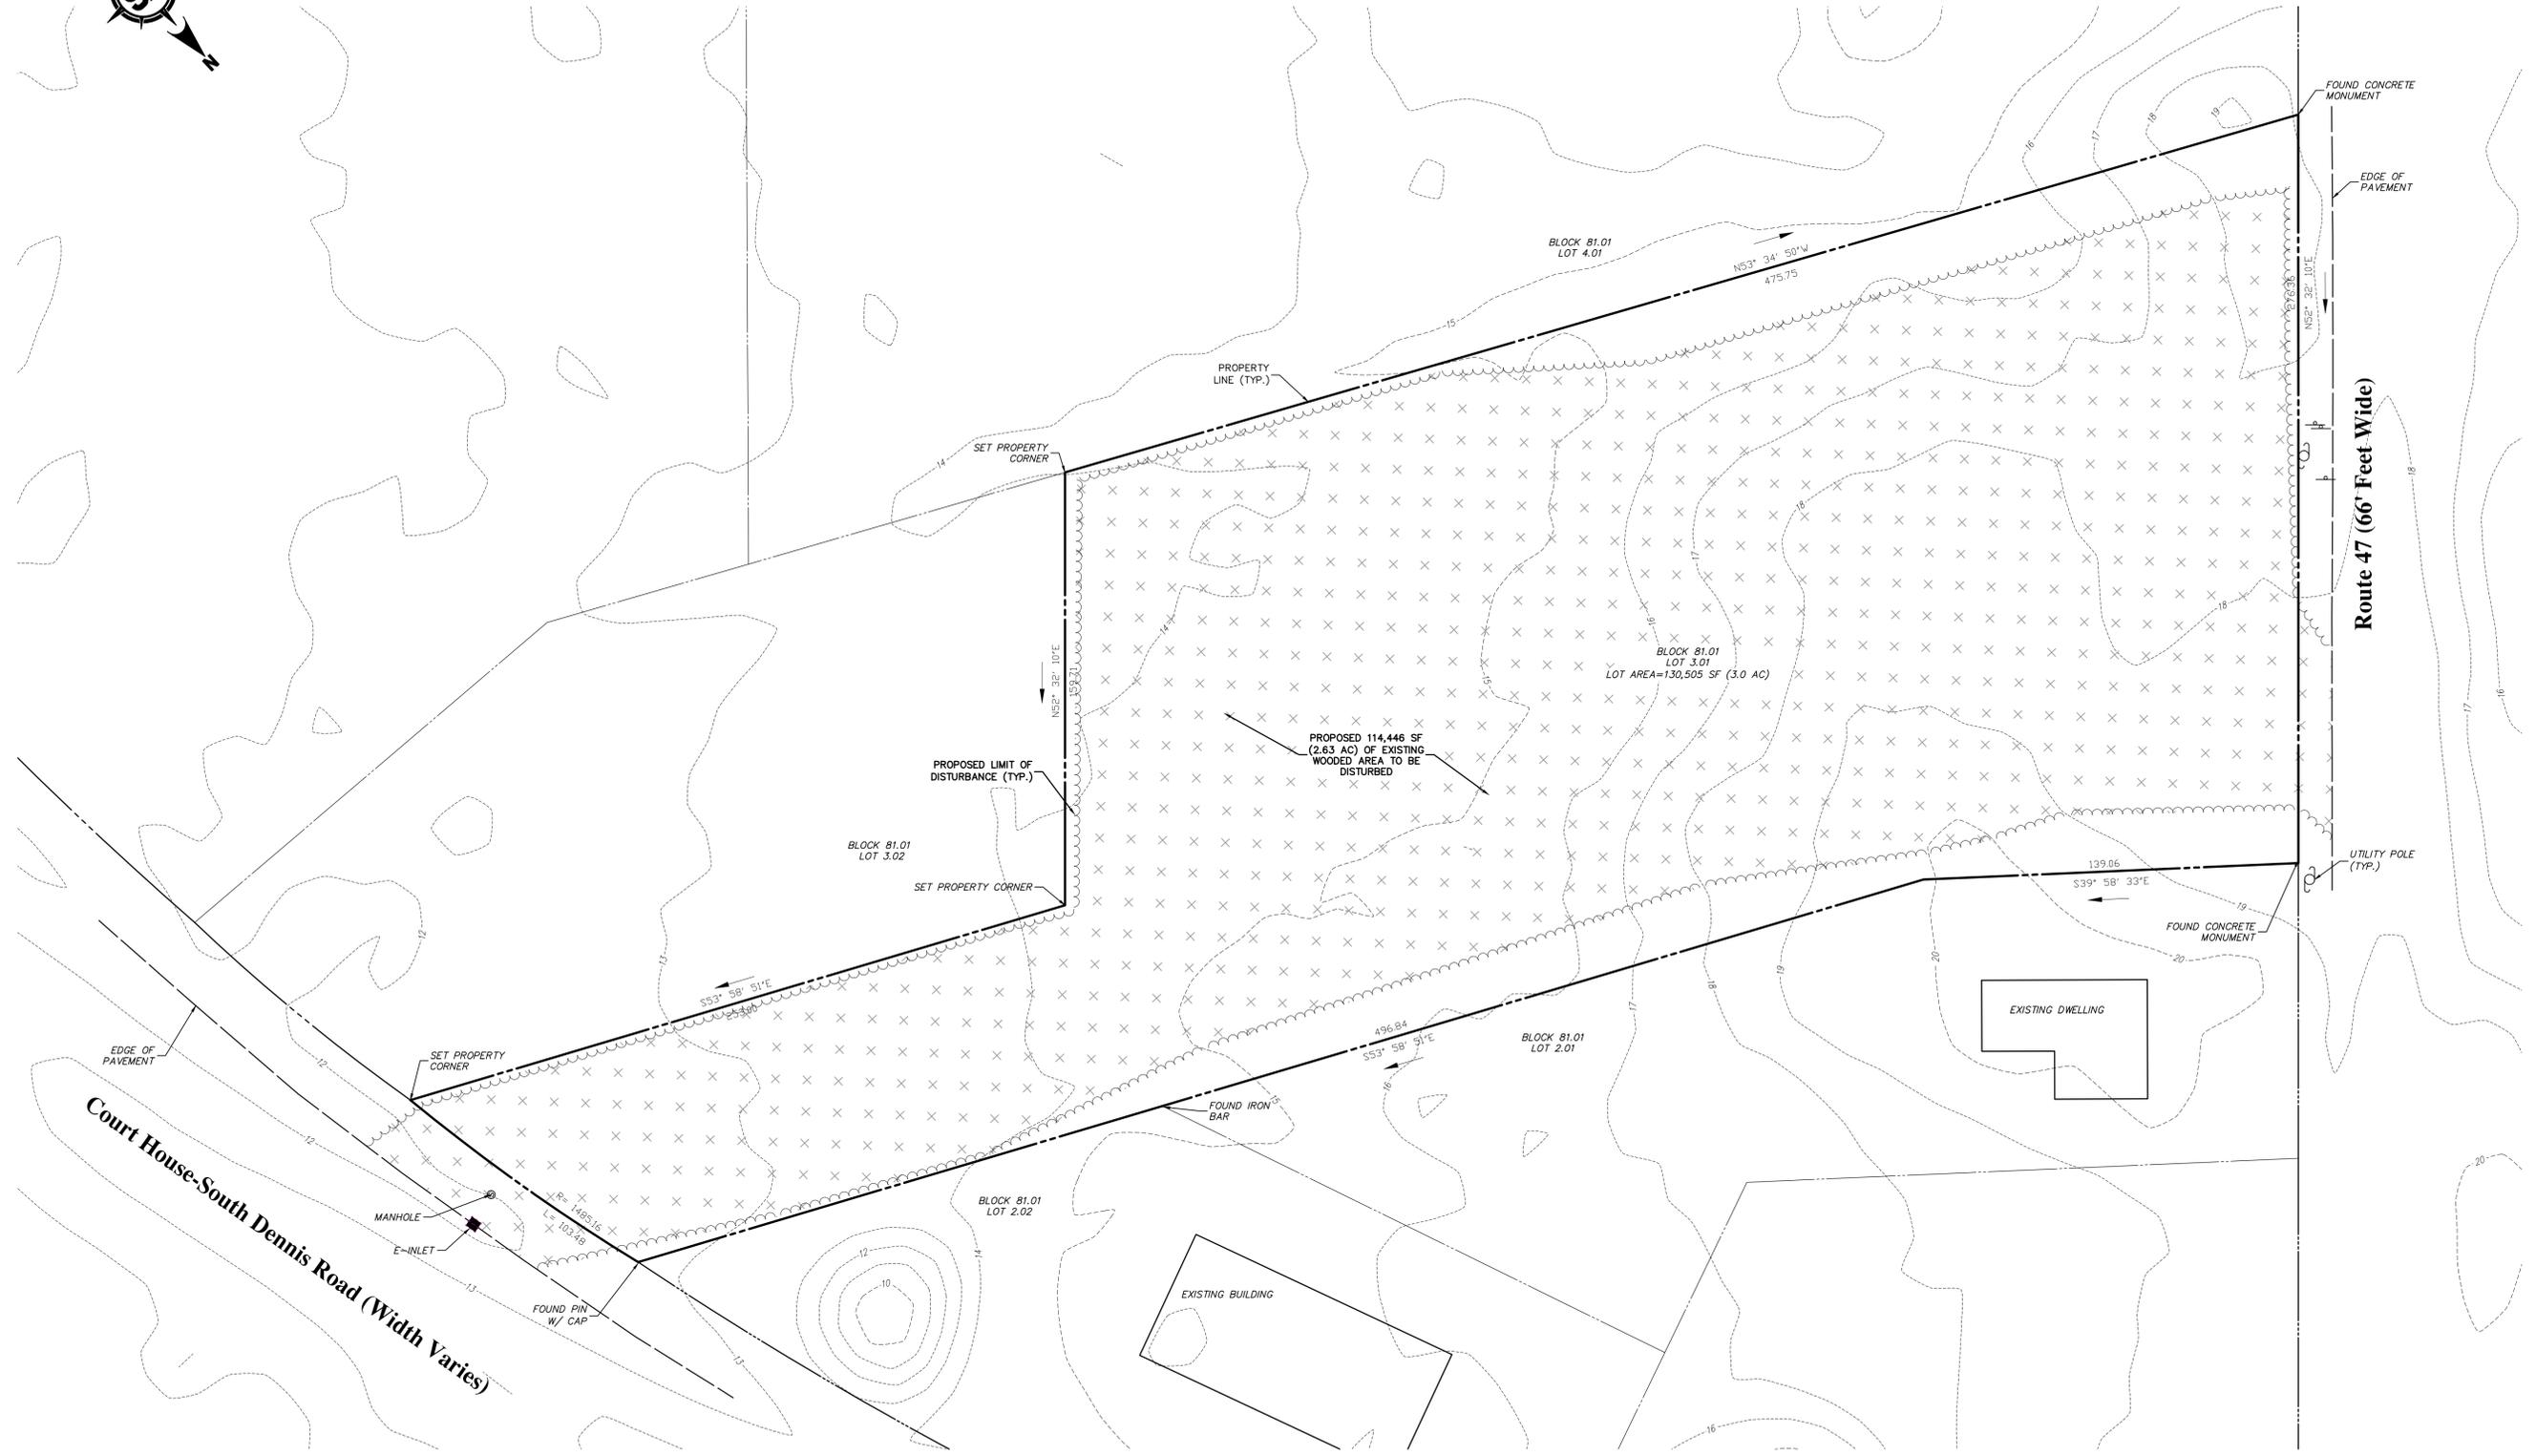

Gregory K. Schneider
 Professional Engineer & Land Surveyor
 New Jersey License No. 42577
 Date: 6/4/2025
 Approved: GKS
 Checked: PdK
 Drawn: TMG
 Designed: PdK



Kates Schneider Engineering, LLC
 Engineers - Surveyors - Planners
 State Board of Professional Engineers & Land Surveyors
 Certificate of Authorization No. 24GA 28200

215 Rt.9 South
 Marmora, New Jersey 08223
 Phone: (609) 885-5177
 Fax: (609) 885-5174
 info@kscevil.com
 www.kscevil.com

By	Date	REVISIONS

Township of Dennis
 Cape May County, New Jersey
Existing Conditions & Demo Plan
 760 Route 47 North
 Block 81.01, Lot 3.01

Job No.	4056.1	Sheet	EXD
B/O	2	Total	11

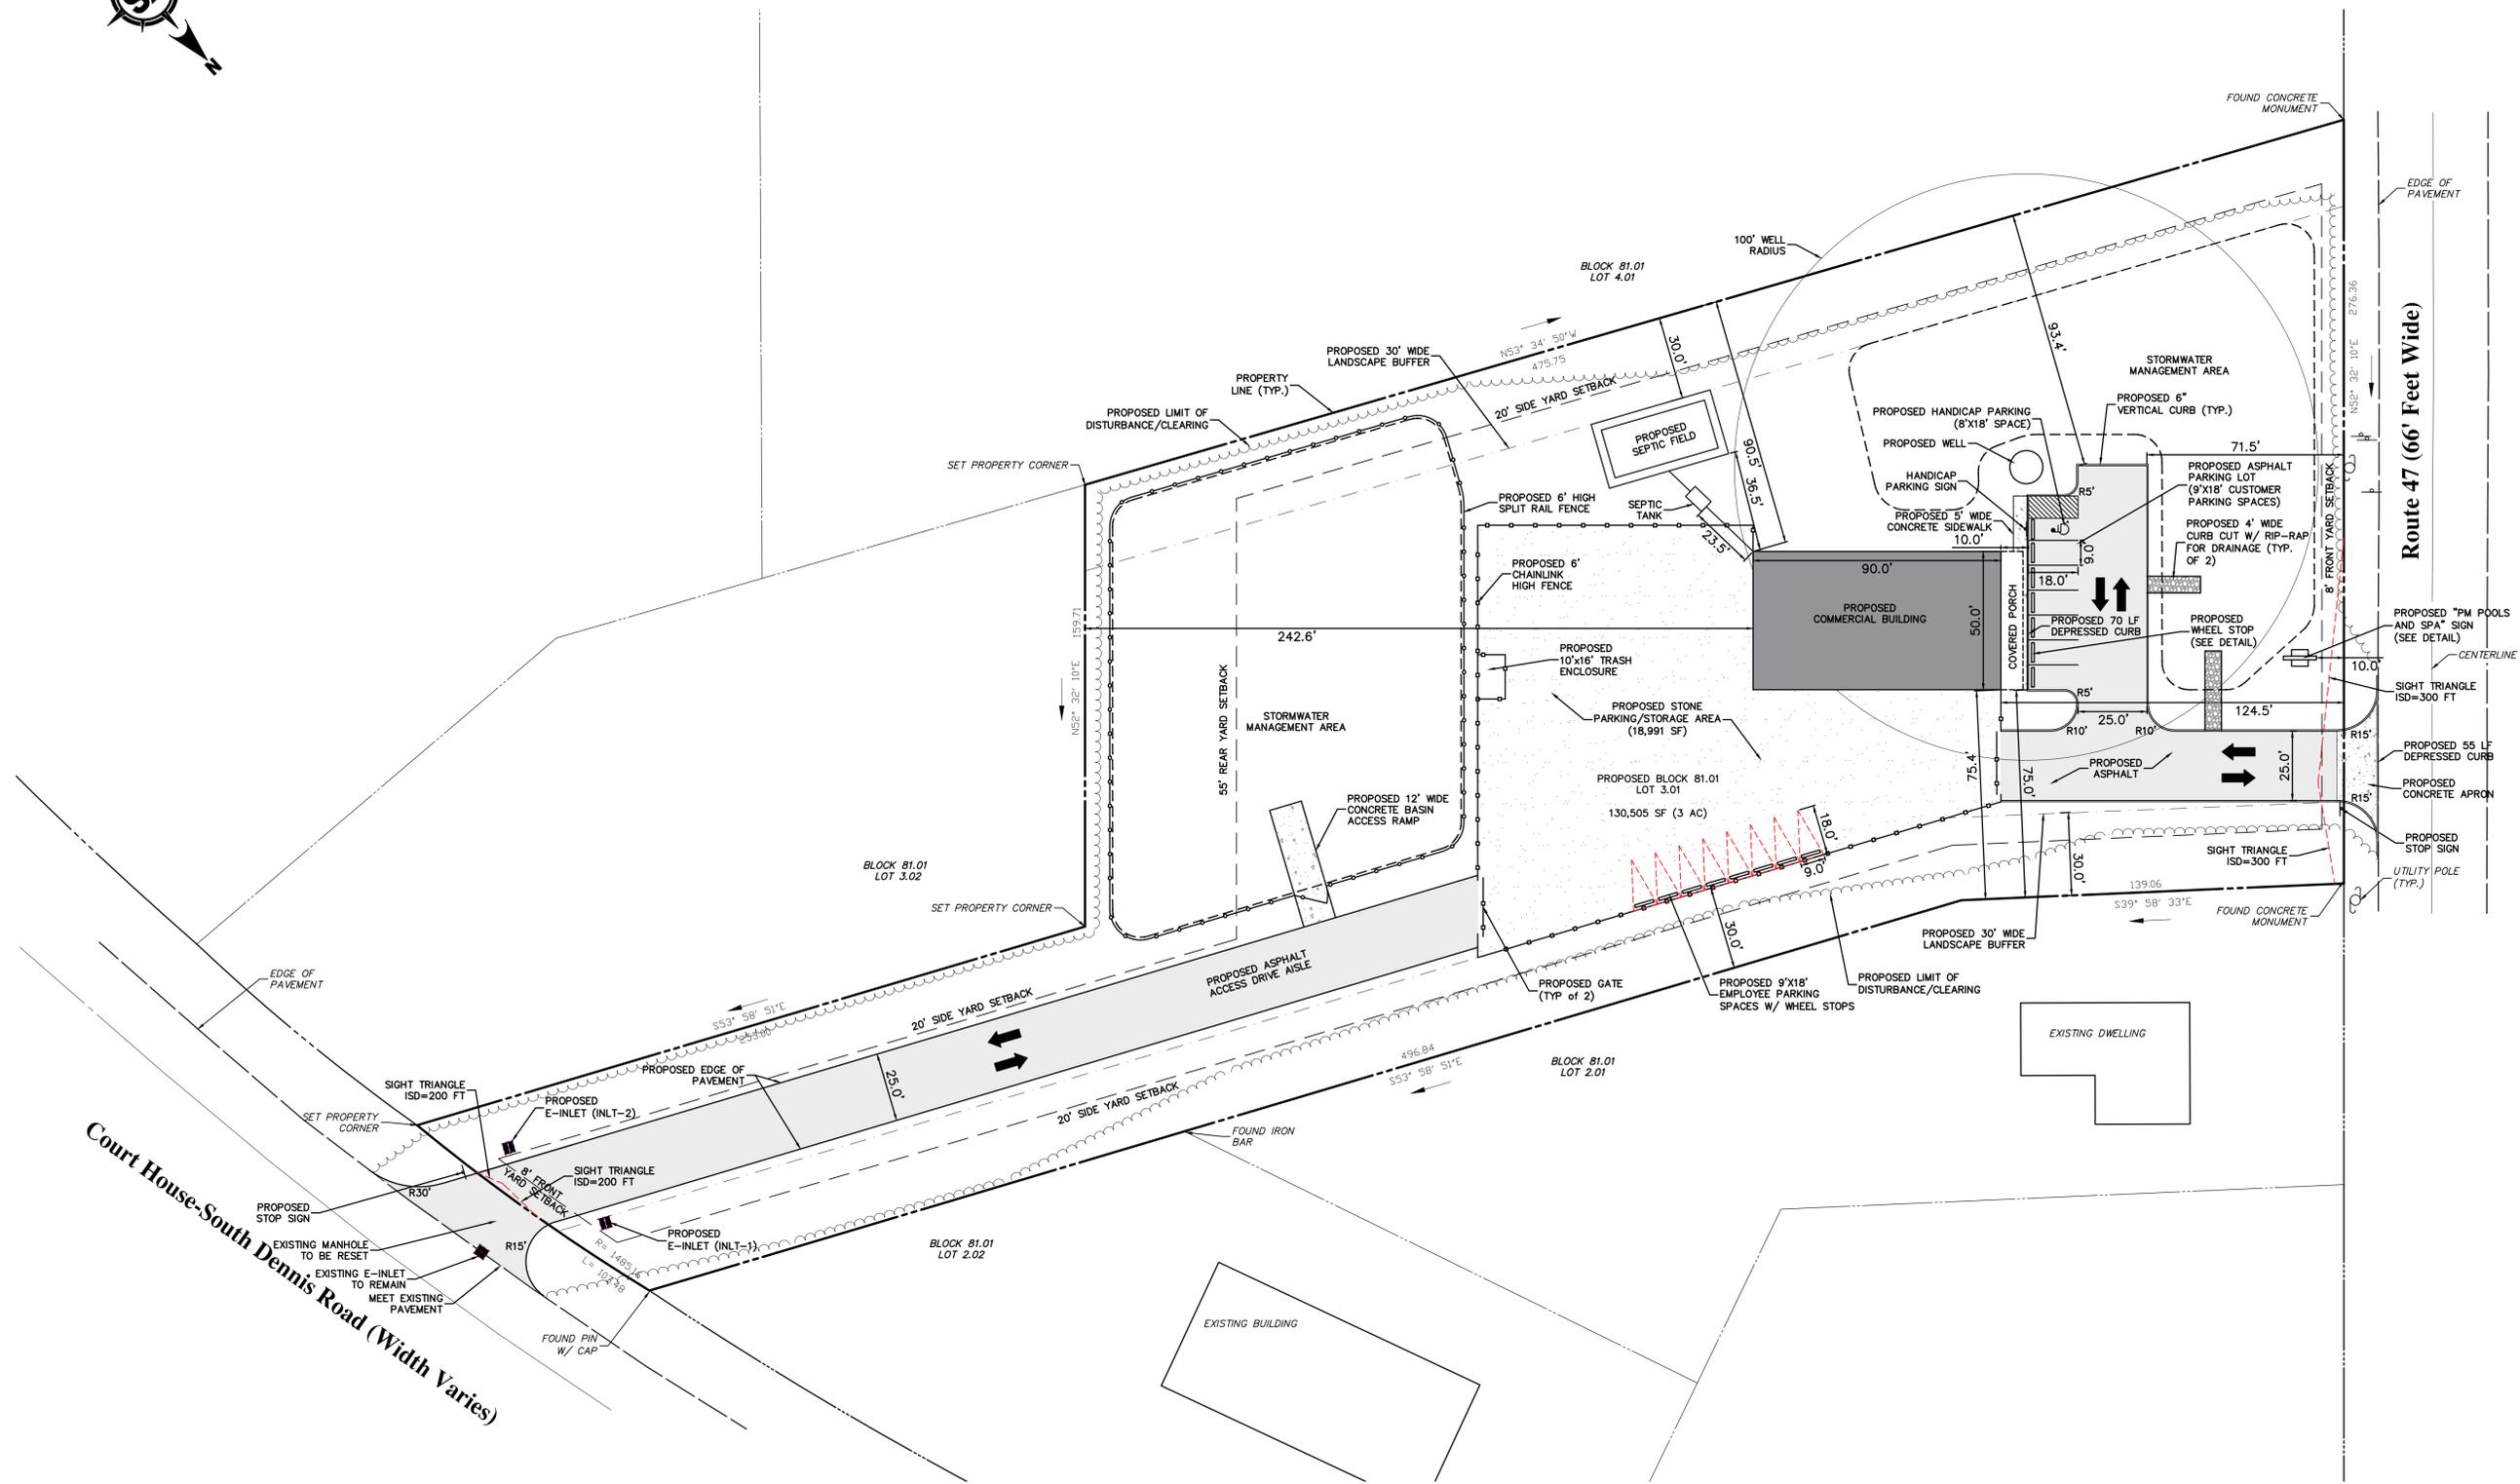

Court House-South Dennis Road (Width Varies)



Gregory K. Schneider
 Professional Engineer & Land Surveyor
 New Jersey License No. 42577
 Date: 6/4/2025
 Approved: GKS
 Checked: PdK
 Drawn: TMG
 Designed: PdK


Kates Schneider Engineering, LLC
 Engineers - Surveyors - Planners
 State Board of Professional Engineers & Land Surveyors
 Certificate of Authorization No. 24GA 28320

215 Rt.9 South
 Marlton, NJ 08053
 Phone: (609) 885-7247
 Fax: (609) 885-2634
 info@ksceivil.com
 www.ksceivil.com

REVISIONS	By	Date

Township of Dennis
 Cape May County, New Jersey
Site Plan
 760 Route 47 North
 Block 81.01, Lot 3.01

Job No.	Sheet
4056.1	SP
B/O	Total
3	11

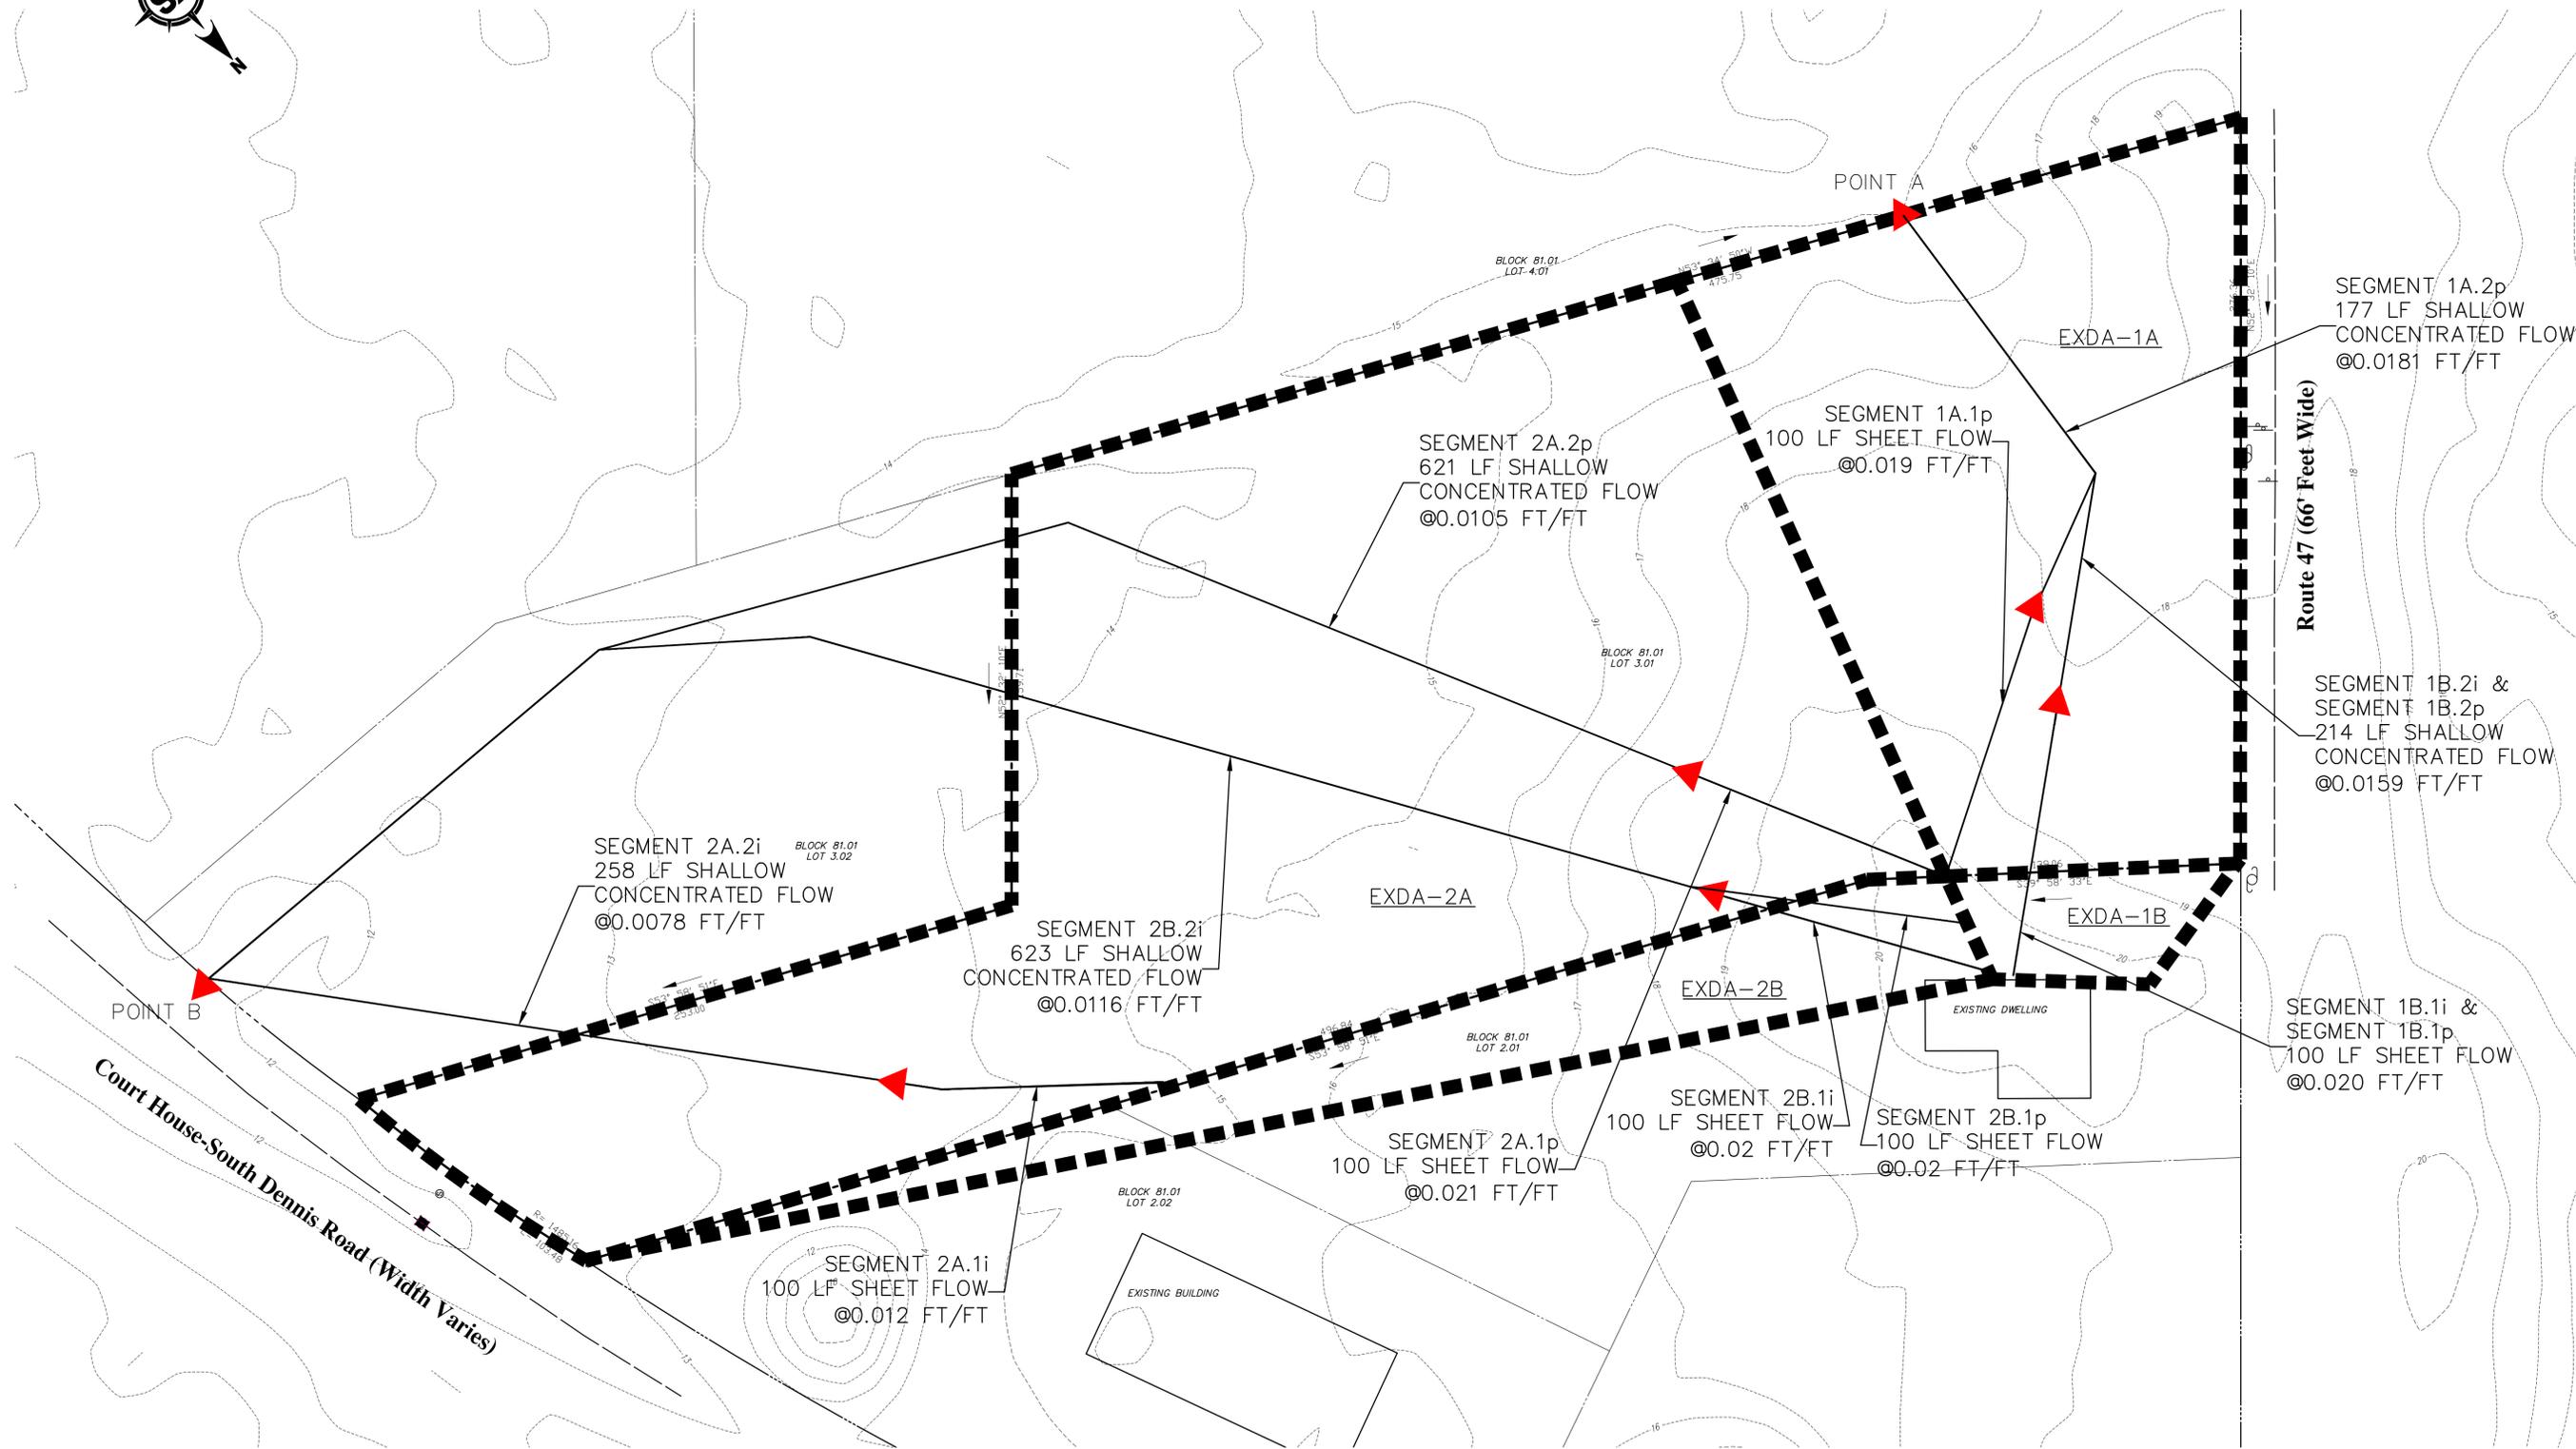

Gregory K. Schneider
 Professional Engineer & Land Surveyor
 New Jersey License No. 42577
 Date: 6/4/2025
 Approved: GKS
 Checked: PDK
 Drawn: TMG
 Designed: PDK


Kates Schneider Engineering, LLC
 Engineers - Surveyors - Planners
 State Board of Professional Engineers & Land Surveyors
 Certificate of Authorization No. 24GA 283200

216 Rt.9 South
 Marmora, New Jersey 08223
 Phone: (609) 885-2477
 Fax: (609) 885-2634
 info@ksecivil.com
 www.ksecivil.com

REVISIONS	By	Date

Township of Dennis
 Cape May County, New Jersey
Pre-Development Drainage
 760 Route 47 North
 Block 81.01, Lot 3.01

Job No.	Sheet
4056.1	Pre-
B/O	Total
5	11

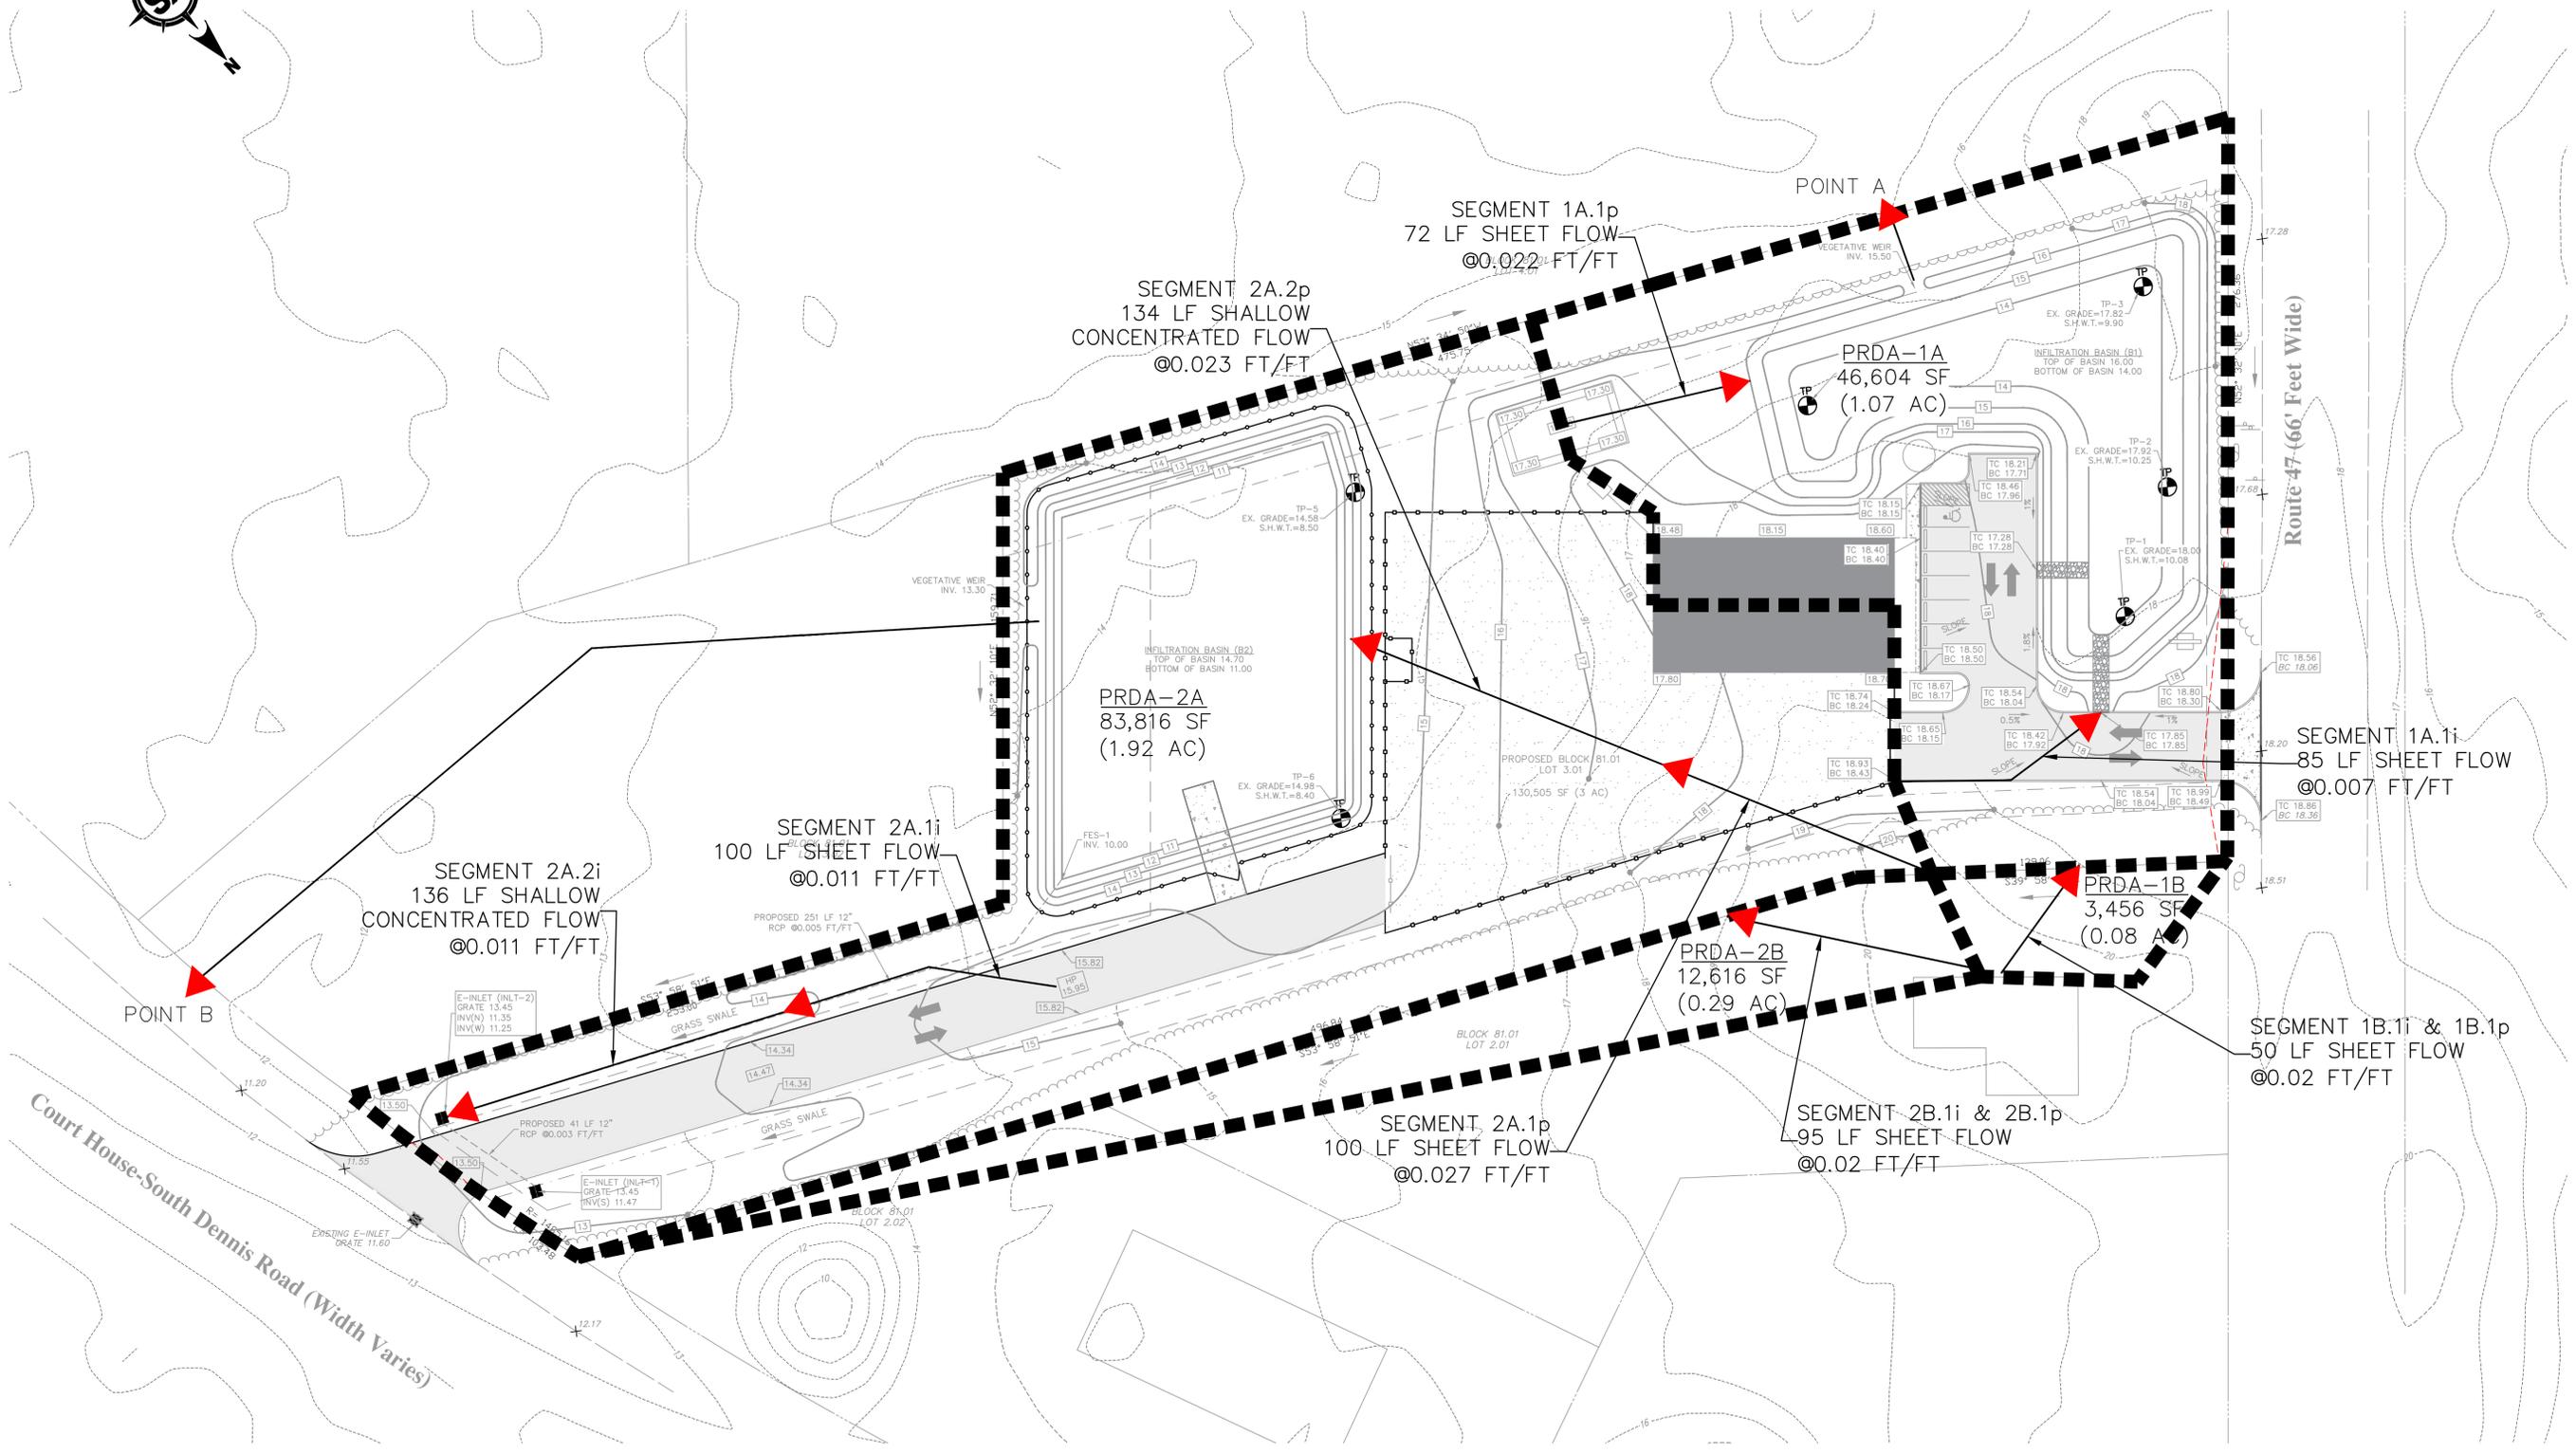

Court House-South Dennis Road (Width Varies)

Route 47 (66' Feet Wide)



Gregory K. Schneider
Professional Engineer & Land Surveyor
New Jersey License No. 42577

Drawn: TMG
Checked: Pdk
Designed: Pdk

Date: 6/4/2025
Approved: GKS
Date: 2/12/25

Kates Schneider Engineering, LLC
Engineers - Surveyors - Planners

State Board of Professional Engineers & Land Surveyors
Certificate of Authorization No. 24GA 283200

215 Rt.9 South
Marmora, New Jersey 08223
Phone: (609) 385-5747
Fax: (609) 385-5744
info@ksecivil.com
www.ksecivil.com


By	Date	REVISIONS

Township of Dennis
Cape May County, New Jersey

Post-Development Drainage

760 Route 47 North
Block 81.01, Lot 3.01

Job No.	Sheet
4056.1	Post-
B/O	Total
6	11

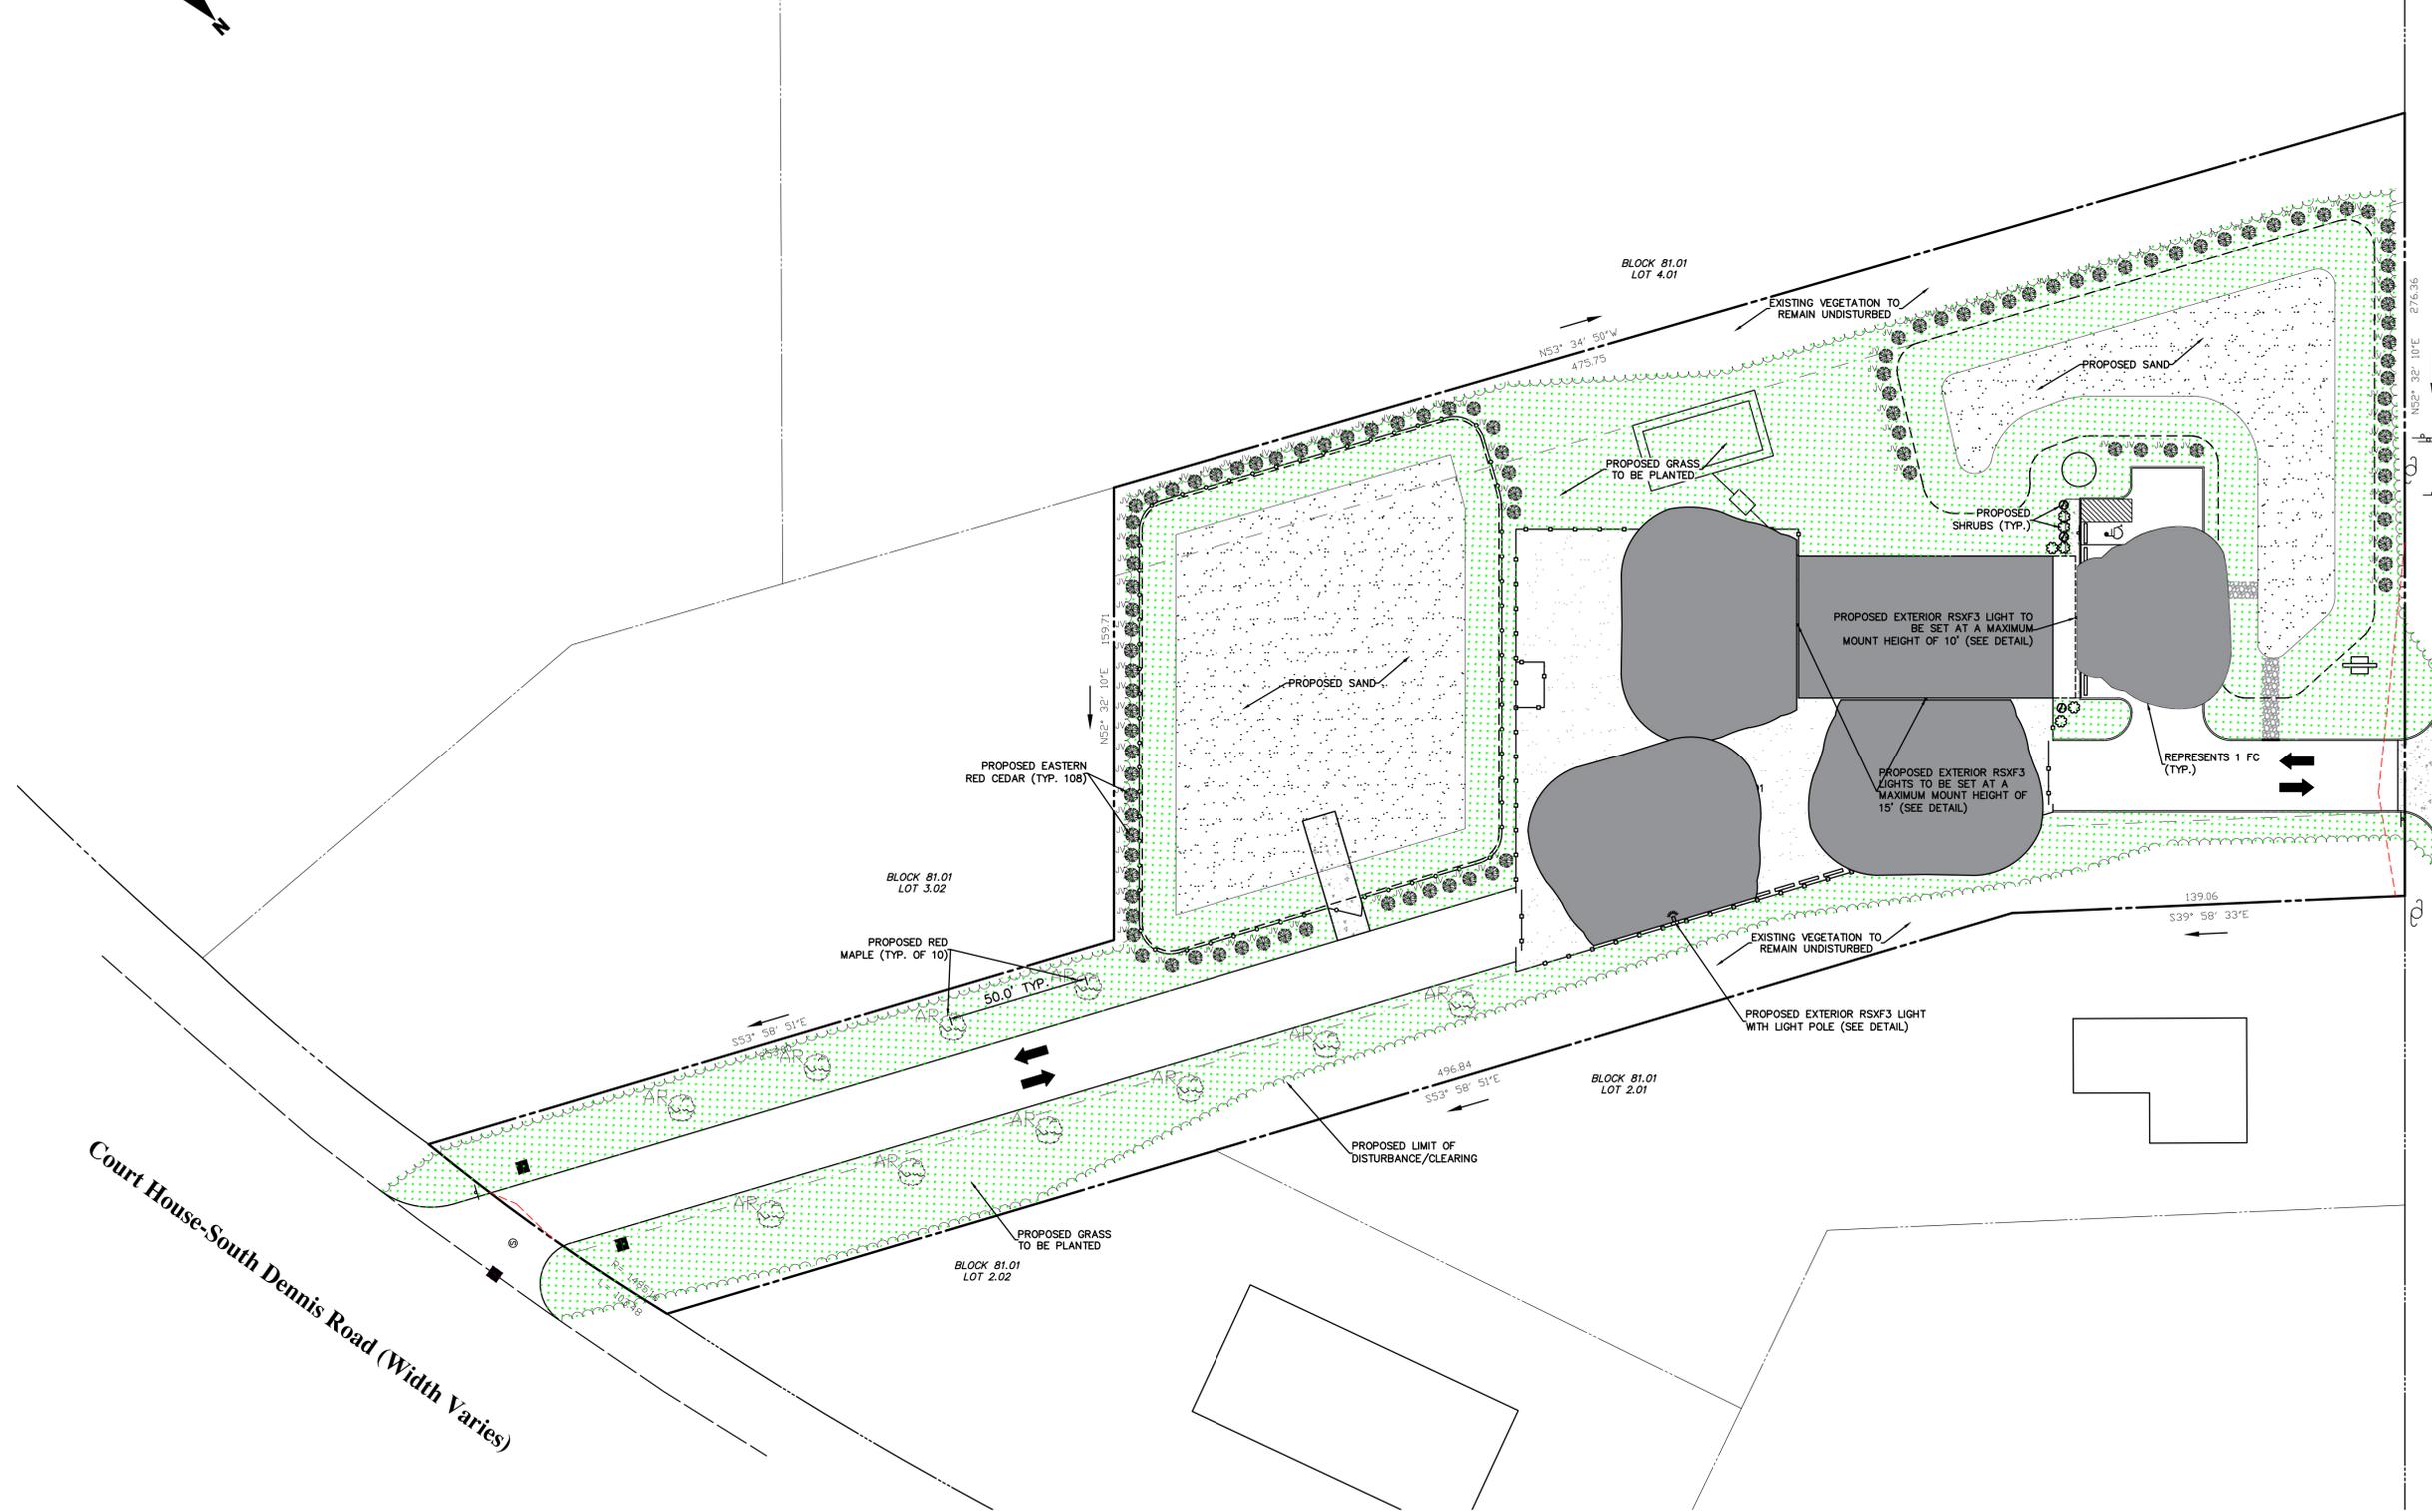

Court House-South Dennis Road (Width Varies)

Route 47 (66' Feet Wide)



Township of Dennis Cape May County, New Jersey Landscape & Lighting Plan 760 Route 47 North Block 81.01, Lot 3.01		Job No. 4056.1	Sheet LL-1																																	
		B/O 7	Total 11																																	
215 Rt.9 South Marmora, New Jersey 08223 Phone (609) 265-2634 Fax (609) 265-2634 info@kscivil.com www.kscivil.com		REVISIONS <table border="1" style="width: 100%; border-collapse: collapse;"> <thead> <tr> <th style="width: 80%;"></th> <th style="width: 10%;">By</th> <th style="width: 10%;">Date</th> </tr> </thead> <tbody> <tr><td> </td><td> </td><td> </td></tr> </tbody> </table>			By	Date																														
	By	Date																																		
 Kates Schneider Engineering, LLC Engineers - Surveyors - Planners State Board of Professional Engineers & Land Surveyors Certificate of Authorization No. 24GA 283200		Designed PdK																																		
Drawn TMG		Checked PdK																																		
Approved GKS		Date 2/12/25																																		
Professional Engineer & Land Surveyor New Jersey License No. 42577 		Approved GKS																																		
Professional Engineer & Land Surveyor New Jersey License No. 42577		Date 6/4/2025																																		



RSXF2 LED Floodlight



Specifications


EPA (ft²@45°): 0.9 ft² (0.08 m²)

Length: 28.3" (71.9 cm)

Width: 13.4" (34.0 cm)

Height: 3.0" (7.6 cm) Main Body
7.6" (19.3 cm) Arm

Weight: 33 lbs (15.0 kg)

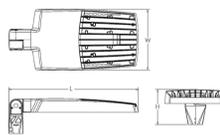

Listing Number _____

Notes _____

Type _____

Use the Tab key to move over the page to see all interactive elements.

Introduction

The new RSXF LED Flood family delivers maximum value by providing significant energy savings, long life and outstanding photometric performance at an affordable price. The RSXF2 delivers 11,000 to 44,000 lumens allowing it to replace 250W to 1000W HID floodlights.

The RSXF features an adjustable integral slipfitter that allows the luminaire to be mounted on a 2-3/8" OD tenon. Integral cover/wire box serves as an approved splice compartment allowing for fast, easy mounting and wiring without opening the electrical compartment. A yoke and other mounting configurations are available.



Items marked by a shaded background qualify for the Design Select program and ship in 15 days or less. To learn more about Design Select, visit www.acuitybrands.com/designselect. *See ordering tree for details.

Design Select options indicated by this color background.

Ordering Information

EXAMPLE: RSXF2 LED P4 40K MFL VOLT IS DDBXD

Series	Performance Package	Color Temperature	Distribution	Voltage	Mounting
RSXF2 LED	P1	30K 3000K	AWFD Area Wide Forward	MVOLT (120V-277V) ¹	IS Adjustable slipfitter (No. 2-3/8" OD tenon) ¹
	P2	40K 4000K	WFL Wide Flood	HVOLT (347V-480V) ¹	YK63 Yoke with 16-3/50 cord, 3ft ¹
	P3	50K 5000K	MFL Medium Flood	XVOLT (277V-480V) ¹	AASP Adjustable tilt arm square pole mounting ¹
	P4		NFL Narrow Flood	(use specific voltage for options as noted)	AARP Adjustable tilt arm round pole mounting ¹
	P5		SP Spot	120 ¹ 277 ¹	AAWB Adjustable tilt arm with wall bracket ¹
	P6		NSP Narrow Spot	208 ¹ 347 ¹	AAWSC Adjustable tilt arm wall bracket and surface conduit box ¹
	P7			208 ¹ 480 ¹	
	P8				

Options

Options	Shipped Installed	Finish
FE Photocell, button style ^{1,2}	Shipped Installed	DDBXD Dark Bronze
PER7 Seven-wire twist-lock receptacle only (no controls) ^{1,10,11}	*Standalone and Networked Sensors/Controls (factory default settings, see table page 9)	DBLXD Black
SF Single hose (120, 277, 347) ¹	NL1AR2 P10IN nLight AIR generation 2, with Networked, 0-1 level motion/ambient sensor ^{1,11,12,14}	DNAXD Natural Aluminum
DF Double hose (208, 240, 480) ¹	BAA Buy America(s) Act Compliant	DWHXD White
SF200KV 200V Super-pack (100V standard)	CCE Coastal Construction ¹⁵	DDB7XD Textured Dark Bronze
FAD Field adjustable output ¹	Shipped Separately (requires some field assembly)	DBL8XD Textured Black
DAG 0-10V dimming extend out back of housing for external control (control ordered separate) ¹⁷	FV Full View (360° around light aperture) ¹⁸	DNAX3D Textured Natural Aluminum
UBV Upper/bottom view ¹⁹	UBV Upper/bottom view ¹⁹	DWHGXD Textured White
DS Dual Switching ¹¹	BS Bird Spikes ¹⁷	

*Note: NL1AR2 P10IN with nLight Air can be used as a standalone or networked solution. Sensor coverage pattern is affected when luminaire is tilted.



COMMERCIAL OUTDOOR One Lithonia Way • Conyers, Georgia 30012 • Phone: 800-705-SERV (7378) • www.acuitybrands.com


Lithonia RSXF2 Flood LED Rev. 04/20/23 Page 1 of 8

Visual - Template Tool

Design Information
Project Description

Name _____
Company _____
Phone _____
Email _____

AcuityBrands
Wednesday, August 30, 2023

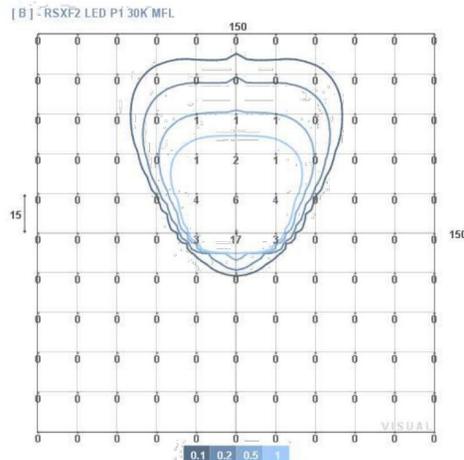


[B] - RSXF2 LED P1 30K MFL



Manufacturer	Lithonia Lighting	Configuration	Single
Lamp Lumens	9873	Orientation	Single
Lamp Quantity	1	Mounting Height	15
Light Loss Factor	1	Arm Length	1
Input Power	72.1	THT	28
Max Illuminance	17	Area × 1.5fc	1378

These lighting calculation results are for general informational purposes only and are provided without warranty as to accuracy, completeness, reliability or otherwise. Results are based on user provided data and data provided from publicly available sources; actual field conditions may affect calculated output. Visit www.Visual-3D.com.

Planting Schedule					
	ABB.	BOTANICAL NAME	COMMON NAME	QTY	SIZE
STREET TREE					
AR	AR	Acer Rubrum	Red Maple	10	2 1/2"-3" Cal.
TREES FOR SCREENING					
JV	JV	Juniperus Virginiana	Eastern Red Cedar	108	2 1/2"-3" Cal.
SHRUBS					
TH		Thuja Occidentalis	Little Giant Dwarf Arborvitae	3	4" wide spread
AZ		Azalea Delaware Valley White	White Azalea	6	18"-24" spread

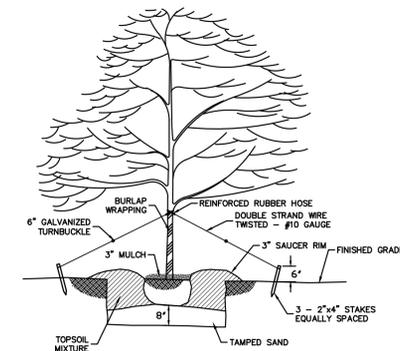

Typical Tree/Shrub Planting Detail
NOT TO SCALE

Planting notes

- Plant material shall be furnished and installed as indicated including all labor, materials, plants, equipment, incidentals and clean-up.
- The contractor shall be responsible for planting at correct grade and alignment.
- Plants shall be typical of their species and variety; have normal growth habits; well developed branches, densely foliated, vigorous root systems and be free from defects and injuries.
- Contractor shall report any soil or drainage conditions considered detrimental to the growth of plant material.
- All plant material shall be guaranteed by the contractor to be in vigorous growing condition. provision shall be made for a growth guarantee of at least one (1) year for trees and a minimum of one (1) growing season for shrubs. Replacements shall be made at the beginning of the first succeeding planting season. all replacements shall have a guarantee equal to that stated above.
- Insofar as it is practicable, plant material shall be planted on the day of delivery. in the event it is not possible, the contractor shall protect slope not planted. plants shall not remain unplanted for longer than a three (3) day period after delivery.
- Quality and size of the plants, spread of roots and size of balls shall be in accordance with ANSI Z60 (REV. 1980) "AMERICAN STANDARD FOR NURSERY STOCK" as published by THE AMERICAN ASSOCIATION OF NURSERMEN, INC.
- All plants shall be planted in topsoil that is thoroughly watered and tamped as backfilling progresses. Nothing but suitable topsoil, free of dry sod, stiff clay, litter, etc. shall be used for planting.
- Plants shall not be bound with wire or rope at any time as to damage the bark and break branches. Plants shall be handled from the bottom of the ball only.
- Planting operations shall be performed during periods within the planting season when weather and soil conditions are suitable and in accordance with acceptable local practice.
- No plant, except ground covers, shall be planted less than two (2) feet from existing structures and sidewalks.
- Set all plants plumb and straight. set at such a level that, after settlement, a normal or natural relationship to the crown of the plant with the ground surface will be established. Locate plants in the center of the pit.
- All injured roots shall be pruned to make clean ends before planting. It is advisable to prune approximately 1/3 of the growth of large trees (6" caliper and over) by the removal of superfluous branches, those which cross, those which run parallel, etc. main leader of trees must not be cut back. Long side branches, however, must be shortened.
- Each tree and shrub shall be pruned in accordance with standard horticultural practice to preserve the natural character of the plant. Pruning shall be done with clean, sharp tools. Cuts over 3/4" in diameter shall be painted with suitable tree paint.
- Trees shall be supported immediately after planting. All trees six (6) inches and over in caliper shall be staked. Smaller trees shall be staked. Guying wires and stakes shall be installed as indicated.
- The trunks of all trees shall be wrapped as soon as possible after planting according to standard procedures and as indicated.

Lighting Details

Details from Lithonia Lighting and can be found at lithonia.acuitybrands.com

Gregory K. Schneider
Professional Engineer & Land Surveyor
New Jersey License No. 42577

Checked: GKS
Approved: GKS
Date: 6/4/2025

Kates Schneider Engineering, LLC
Engineers - Surveyors - Planners

State Board of Professional Engineers & Land Surveyors
Certificate of Authorization No. 24GA 28320

216 Rt.9 South
Marmora, New Jersey 08223
Phone: (609) 785-2677
Fax: (609) 785-2634
info@kscevil.com
www.kscevil.com


By _____
Date _____

REVISIONS

By _____
Date _____

Job No. 4056.1
Sheet LL-2
B/C 8
Total 11

Township of Dennis
Cape May County, New Jersey
Landscape & Lighting Details
760 Route 47 North
Block 81.01, Lot 3.01

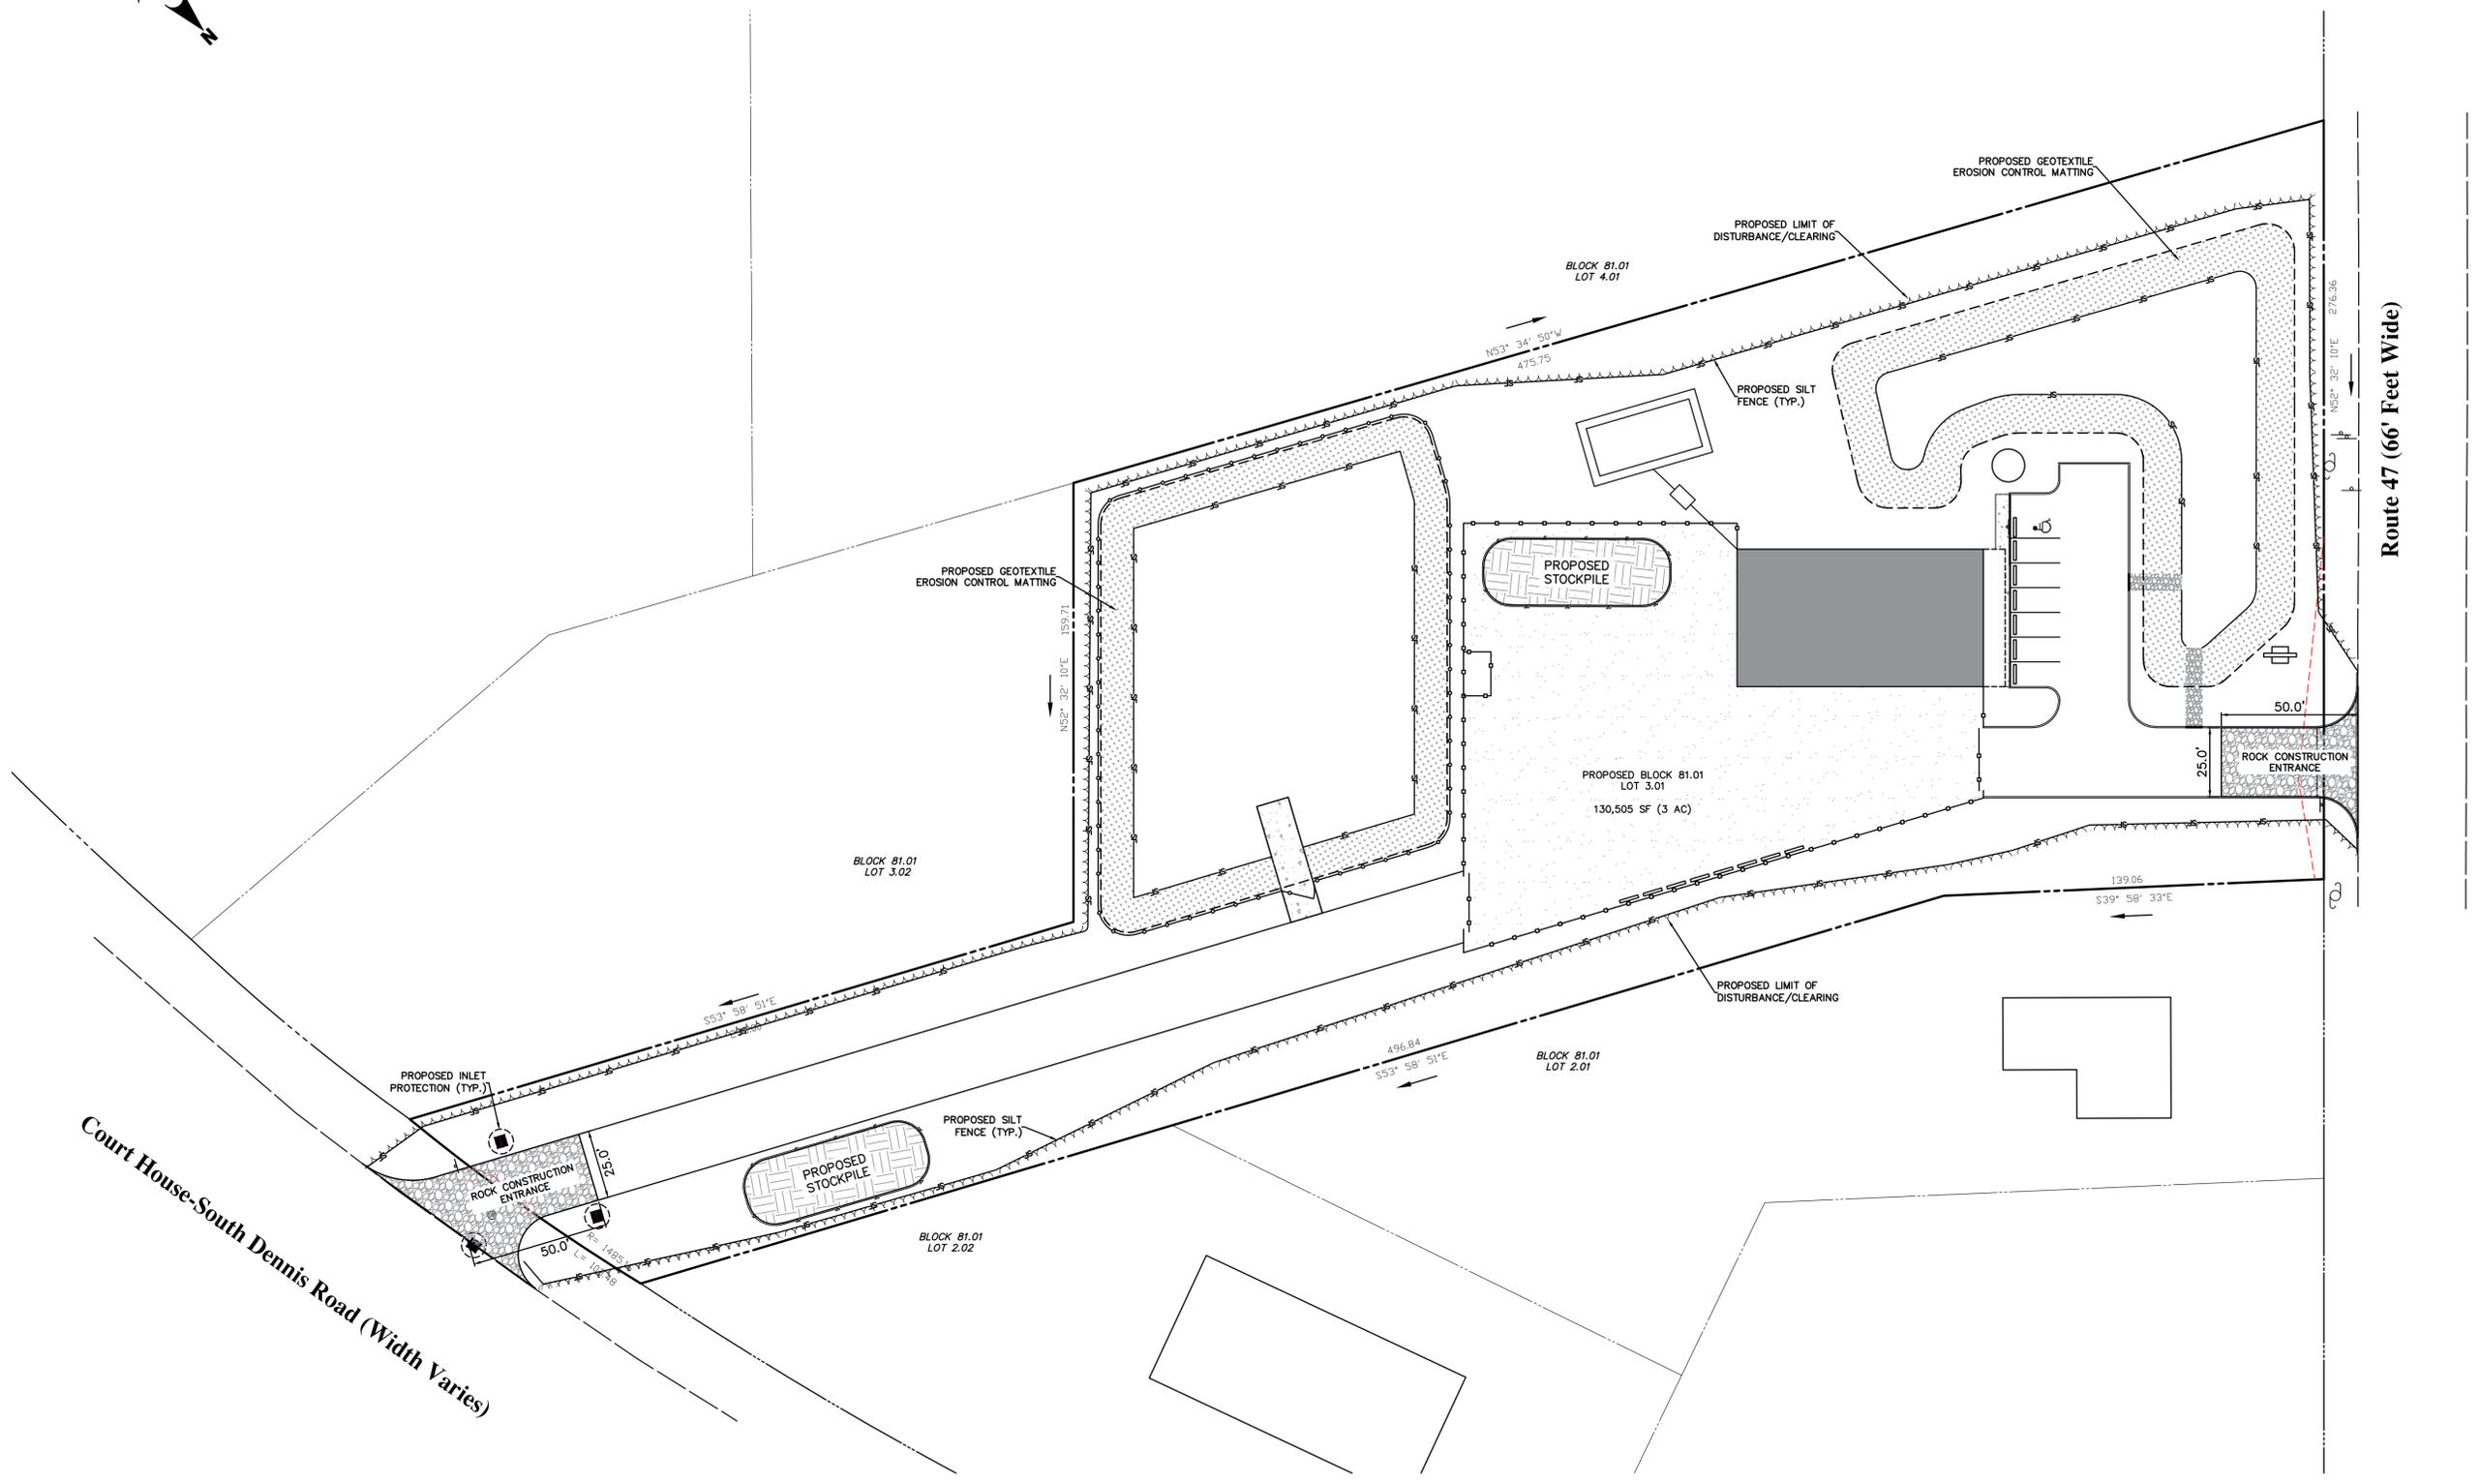

Court House-South Dennis Road (Width Varies)

Route 47 (66' Feet Wide)




Township of Dennis Cape May County, New Jersey Soil Erosion & Sediment Control Plan 760 Route 47 North Block 81.01, Lot 3.01		Job No. 4056.1	Sheet SESC-1
		B/O 9	Total 11
215 Rt.9 South Marmora, New Jersey 08223 Phone: (609) 385-1747 Fax: (609) 385-2884 kates@ksecvill.com www.ksecvill.com		Kates Schneider Engineering, LLC Engineers - Surveyors - Planners <small>State Board of Professional Engineers & Land Surveyors Certificate of Authorization No. 24GA 293200</small>	
Gregory K. Schneider Professional Engineer & Land Surveyor New Jersey License No. 42577 <i>GKS</i>		Designed Pdk	Drawn TMG
Checked Pdk		Approved GKS	Date 2/12/25
REVISIONS		By	

RSALP Round Straight Aluminum Poles, Low Profile

Shaft base size	Shaft dia.	Shaft projection	Base square	Template description	Anchor bolt description	Bolt size (in. x in. x lbs.)
4"	4.375"	3.50"	8.50"	ARTWORK KIT P10007	ARB0.0	3/4 x 18 x 3
4.5"	4.500"	3.50"	9.00"	ARTWORK KIT P10040	ARB0.0	3/4 x 18 x 3
5"	4.875"	3.50"	10.00"	ARTWORK KIT P10071	ARB0.0	3/4 x 18 x 3


ROUND ALUMINUM HANDLE AND FESTOON - PLACEMENT RULES

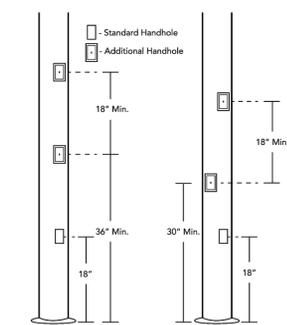

© 2008 Lithonia Lighting. All rights reserved. Lithonia Lighting reserves the right to change material or design without prior notice. See accompanying sheet for applicable products.


LIGHT POLE & BASE DETAIL

Details from Lithonia Lighting and can be found at lithonia.acuitybrands.com

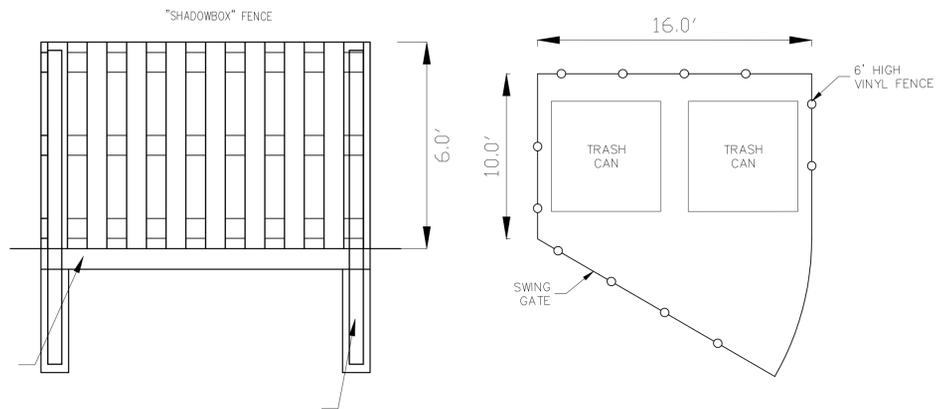


TRASH ENCLOSURE DETAIL

NOT TO SCALE

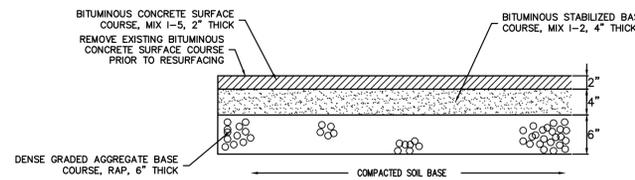


PAVEMENT SECTION DETAIL

NOT TO SCALE

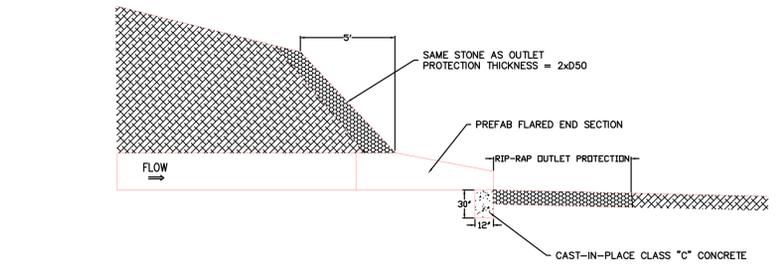

FLARED END SECTION HEADWALL (FES-1)


NOT TO SCALE

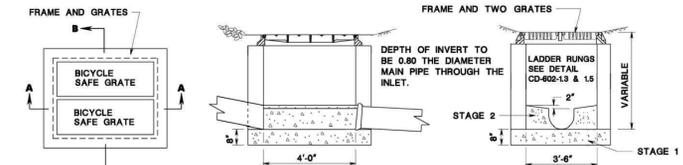

INLET TYPE E

INLET TYPE E


NOT TO SCALE

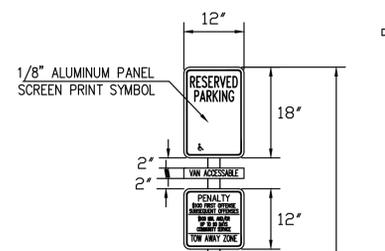

1/8\"/>

NOT TO SCALE

2 1/2" STEEL "U"-POST (2.5 LBS./FT) HOT DIP GALV. AFTER FABRICATION IN COMPLIANCE WITH NJDOT STANDARD SPECIFICATIONS AND M.U.T.C.D.

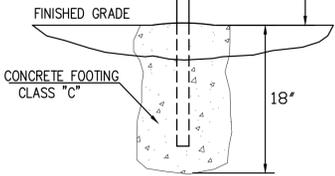


HANDICAP STALL LAYOUT

NOT TO SCALE


"PM POOLS AND SPA" SIGN DETAIL

NOT TO SCALE

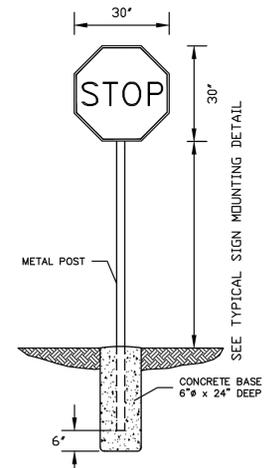


STOP SIGN (R1-1)

NOT TO SCALE

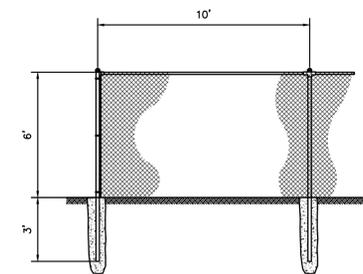


CHAIN LINK FENCE, 6' HIGH

NOT TO SCALE

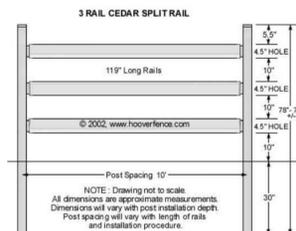


SPLIT RAIL FENCE, 6' HIGH

NOT TO SCALE

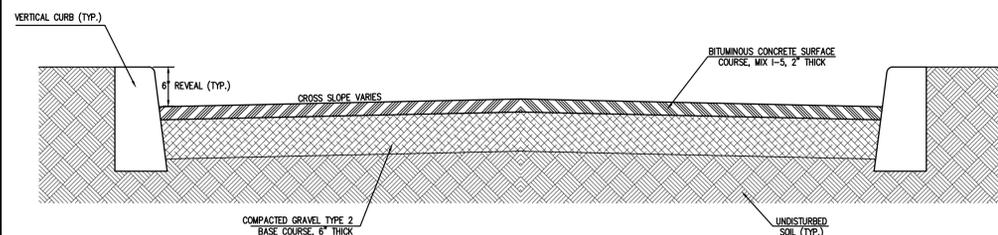


TYPICAL PAVING SECTION

NOT TO SCALE

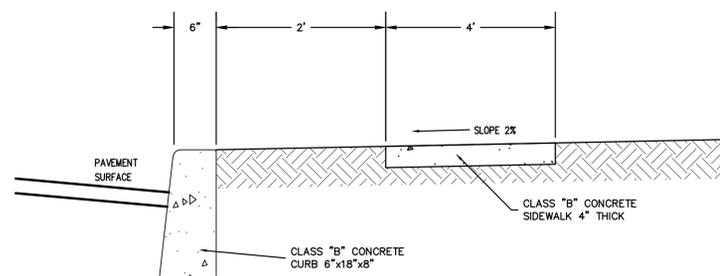


Concrete Sidewalk

NOT TO SCALE

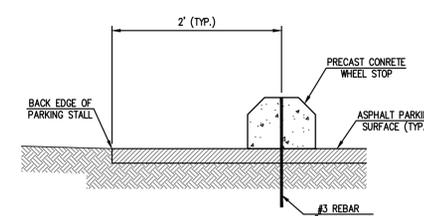

CONCRETE WHEEL STOP

NOT TO SCALE
DRAWN 1:1

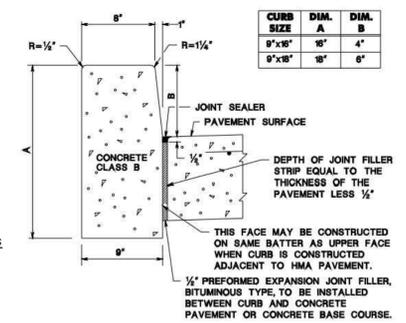

6\"/>

NOT TO SCALE

Gregory K. Schneider
 Professional Engineer & Land Surveyor
 New Jersey License No. 442577
 Date: 6/4/2025
 Approved: GKS
 Checked: PdK
 Drawn: TMG
 State Board of Professional Engineers & Land Surveyors
 Certificate of Authorization No. 24GA 283200

Kates Schneider Engineering, LLC
 Engineers - Surveyors - Planners
 State Board of Professional Engineers & Land Surveyors
 Certificate of Authorization No. 24GA 283200

216 Rt.9 South
 Marmora, New Jersey 08223
 Phone: 609-865-2627
 Fax: 609-865-2634
 info@kscecvil.com
 www.kscecvil.com

Job No. 4056.1
 Sheet 11 of 11
DETAILS
 Total 11